CONSTRUCTION DOCUMENT SET FOR:

SOUTH CENTRAL LOUISIANA HUMAN SERVICES AUTHORITY

TOWN HALL RENOVATION

805 BARROW ST. HOUMA, LA 70360

STATE OF LOUISIANA
JEFF LANDRY - GOVERNOR

DIVISION OF ADMINISTRATION
TAYLOR BARRAS - COMMISSIONER OF ADMINISTRATION

OFFICE OF FACILITY PLANNING AND CONTROL ROGER HUSSER - DIRECTOR




ARCHITECTS PROJECT NO. 2023.04 - NEW OFFICE BUILD OUT DATE: MARCH 15, 2024

PROJECT DIREC	TORY	PROJECT DESCRIPTION	LEGEND		INDEX	OF DRAWINGS CONT.	GENERAL NOTES
OWNER:	MEP ENGINEERS:	PROPERTY	SYMBOLS	DESCRIPTION	DWG. NO.	. TITLE/DESCRIPTION	CONTRACTOR SHALL PROTECT BUILDING AND CONTENTS FROM DAMAGE DURING WORK. ANY DAMAGE SUSTAINED DURING THIS WORK WILL BE CORRECTED BY
UMAN SERVICES AUTHORITY ONTACT: KRISTIN BONNER EXECUTIVE DIRECTOR 58 REGAL ROW	ADG BATON ROUGE, L.L.C. CONTACT: FRANK THOMPSON, P.E. 10705 RIEGER ROAD BATON ROUGE, LA 70809 PH: (225) 293-9474	TOWN HALL 805 BARROW STREET HOUMA, LA 70360	CLASSROOM	ROOM NAME ROOM NUMBER	ARCHITE	INDEX CTURAL:	CONTRACTOR AT HIS COST. 2. ANY DESTRUCTION TO EXISTING GROUNDS INCLUDING SOD, LANDSCAPING, PARILOT, WALKWAYS, AND WALKWAY CANOPIES THAT MAY OCCUR DURING THE COUF THE WORK WILL BE REPAIRED AT CONTRACTOR'S EXPENSE. 3. CONTRACTOR TO COORDINATE AREAS FOR DAILY CLEANING. 4. CONTRACTOR TO HAVE ACCESS TO SITE ON A SEVEN (7) DAY / TWENTY FOUR (24)
OUMA, LA 70360 H: (985) 58-2931		APPLICABLE CODES AND STANDARDS	ELEV=0'-0"	GRADE / ELEV. POINT	A100 A101	DEMOLITION FLOOR PLAN FLOOR PLAN	HOUR TIME COORDINATE THIS SCHEDULE, IF NEEDED, WITH OWNER. PROVIDE CONSTRUCTION KEY LOCKS.
RCHITECT: RCHESTRATE LLC ONTACT: SHELLEY OLIVIER, AIA		INTERNATIONAL BUILDING CODE 2021: BUSINESS NFPA 101: LIFE SAFETY CODE 2021: BUSINESS ADA-ABA ACCESSIBILITY GUIDELINES 2010		REVISION MARK	A120 A300 A360	REFLECTED CEILING PLAN PARTITION TYPES AND DETAILS LIGHT METAL FRAMING	5. CONTRACTOR TO CONSULT WITH OWNER'S I.T. PERSONNEL BEFORE CLOSING I WALLS.6. ALL REFRIGERATORS AND MICROWAVES PROVIDED BY OWNER.
340 WEST TUNNEL BLVD. JITE 420				REVISION CLOUD	A400 A401 A402	ENLARGED ADA PLANS/RESTROOM ELEVATIONS ADA DETAILS INTERIOR ELEVATIONS	
DUMA, LA 70360 1: (985) 266-5553		CONSTRUCTION TYPE	A	WINDOW - LOUVER TAG	A530 A531 A532	MILLWORK MILLWORK MILLWORK	
		IBC TYPE: II-B CONSTRUCTION TYPE: *EXISTING BUILDING IS EQUIPPED WITH AN AUTOMATIC	1	DOOR SYMBOL	A533 A534	MILLWORK MILLWORK	
		EXTINGUISHING SPRINKLER SYSTEM	3	KEY NOTE	A535 A610 A620	MILLWORK FINISH SCHEDULE DOOR AND WINDOW DETAILS	
UILDING AREA				CELLING KEY NOTE	MECHANI	CAL:	
LHSA BUILDING OFFICE AREA	22,053 SQ. FT.			CEILING KEY NOTE	M100	DEMO MECHANICAL PLAN	
SITE MAP			3	PARTITION TYPE	M101 M200	MECHANICAL PLAN MECHANICAL SCHEDULES	
Spigots Brew Pub	The same of the sa		00 A 000	DETAIL REF.: <u>DWG NO.</u> SHEET NO.	M300	MECHANICAL DETAILS	
Spigots blewings	NAPA Auto Parts - Auto			COLUMN GRID MARK	PLUMBING	<u>G:</u>	
St	Auto paris store	S S S S S S S S S S S S S S S S S S S	(1) (A)———————————————————————————————————	COLUMN GRID LINE	P100 P101	DEMO PLUMBING PLAN SANITARY SEWER PLAN	
5	High St High St	d I g			P102 P200	DOMESTIC WATER PLAN PLUMBING SCHEDULES & DETAILS	
First Horizon Bank	06680	High St	MATERIAL LEGEND:	PLAN AND SECTION	FIRE PRO	OTECTION:	
	Cristiano Ristorante Italian • SSS	Hiligh St	EARTH/COMPACT	T FILL STEEL	FP100	FIRE PROTECTION PLAN	
	The same of the sa	P. Ave	SAND	FINISH WOOD	FP200	FIRE PROTECTION DETAILS	
			CONCRETE	ROUGH WOOD	ELECTRIC		
			BRICK	WOOD BLOCKING	E0.0 E1.0 E2.0	ELECTRICAL COVER SHEET ELECTRICAL ONE-LINE DEMO ELECTRICAL PLAN BASE BID ONE-LINE	
	Point St		CONCRETE BLOC	SOUND BLANKET INSULATION	E5.0 E5.0 E6.0	ALTERNATE #3 ONE-LINE OVERALL POWER PLAN POWER PLAN - MECHANICAL	PROJECT ALTERNATES
Appliance store	S GEFE	Point St	PLYWOOD - SM S	SCALE RIGID INSULATION	E7.0 E8.0 E9.0	POWER PLAN ENLARGED VIEWS OVERALL LIGHTING PLAN ELECTRICAL SCHEDULES 1	ALTERNATIVE NO. 1 - SOUND BLANKET INSULATION (ADD ALTERNATE)
Houma Mortgage	Regions Bank Fires	ser itus kita new	PLYWOOD - LG Se	CALE ACOUSTICAL TILE	E10.0 E11.0	ELECTRICAL SCHEDULES 2 ELECTRICAL DETAILS	BASE BID ITEM: SOUND BLANKET INSULATION IN DESIGNATED WALLS PE SHEET A101. DETAIL ON SHEET A300.
& Loan		C stellto Ima	GLASS	GYPSUM BOARD			ALTERNATIVE ITEM: PROVIDE SOUND BLANKET INSULATION IN ALL WALL ALTERNATIVE NO. 2 - HIGH ABUSE GYPSUM BOARD
Academy St	DDO IECT CITE		METAL STUD WAI	LL			(ADD ALTERNATE) BASE BID ITEM: 5/8" GYPSUM BOARD. 5/8" FIRE RATED WHERE INDICATED
182	PROJECT SITE		ELEVATION				ALTERNATIVE ITEM: USE 5/8" HIGH ABUSE GYPSUM BOARD. 5/8" FIRE WHERE INDICATED.
			CMU	GLASS			
Midas 🕒		Academy St	CIVIO				ALTERNATIVE NO. 3 - GENERATOR DOCKING STATION (ADD ALTERNATE)
all stop V		g kg	BRICK				BASE BID ITEM: NO SCOPE.
TE "		Aye.	BRICK				ALTERNATIVE ITEM: INSTALL PORTABLE GENERATOR DOCKING STATIO TRANSFER SWITCH. SEE ELECTRICAL DRAWINGS.
nolia drugs		Town Hall	CONCRETE	PLASTER			
		Tunnel Blvd					
Boost Mobile Cell phone store	Clay St	Ambulance Service					

West Tunnel Blvd 420 na, LA 70360 266.5553 .archestrate.com

1340 W Suite 42 Houma, 985.266 www.ar

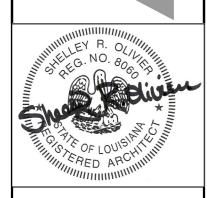

SOUTH CENTRAL LOUISIANA HUMAN SERVICES AUTHORITY 805 BARROW ST. HOUMA, LA 70364

NO. SUBMISSION DATE

3 SCHEMATIC DESIGN 7/12/23

4 SCHEMATIC DESIGN 11/9/23

5 SCHEMATIC DESIGN 12/3
6 SCHEMATIC DESIGN 1/29
7 BID SET 3/19

7 BID SET 3/15


DRAWN BY: PMC


PROJECT NUMBER: 2023.04
SHEET TITLE


INDEX

SHEET NO.


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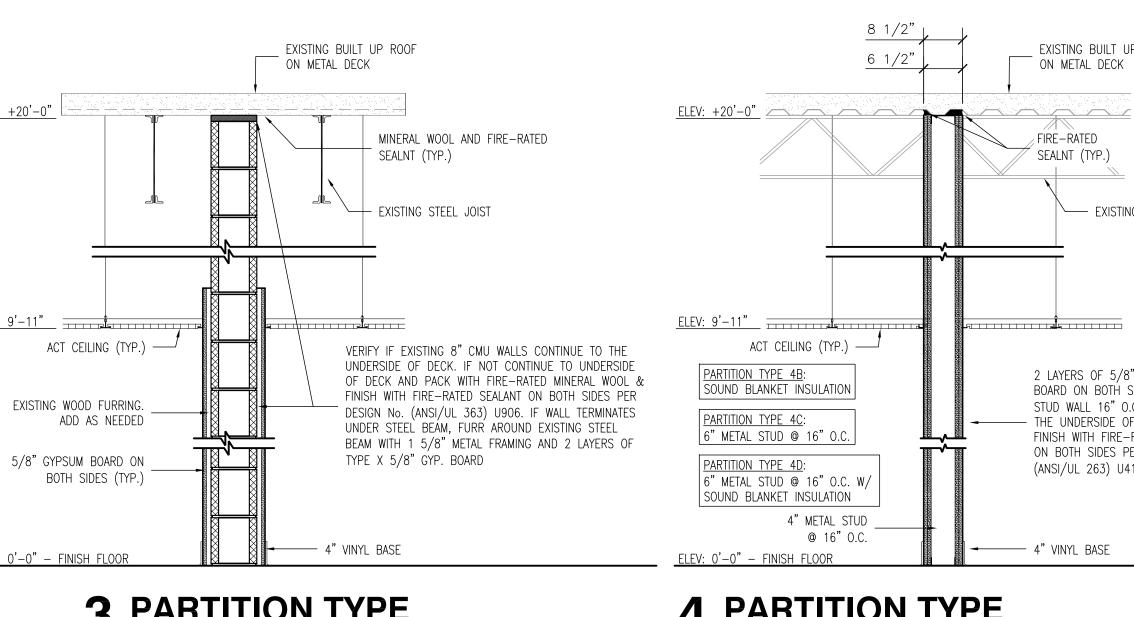


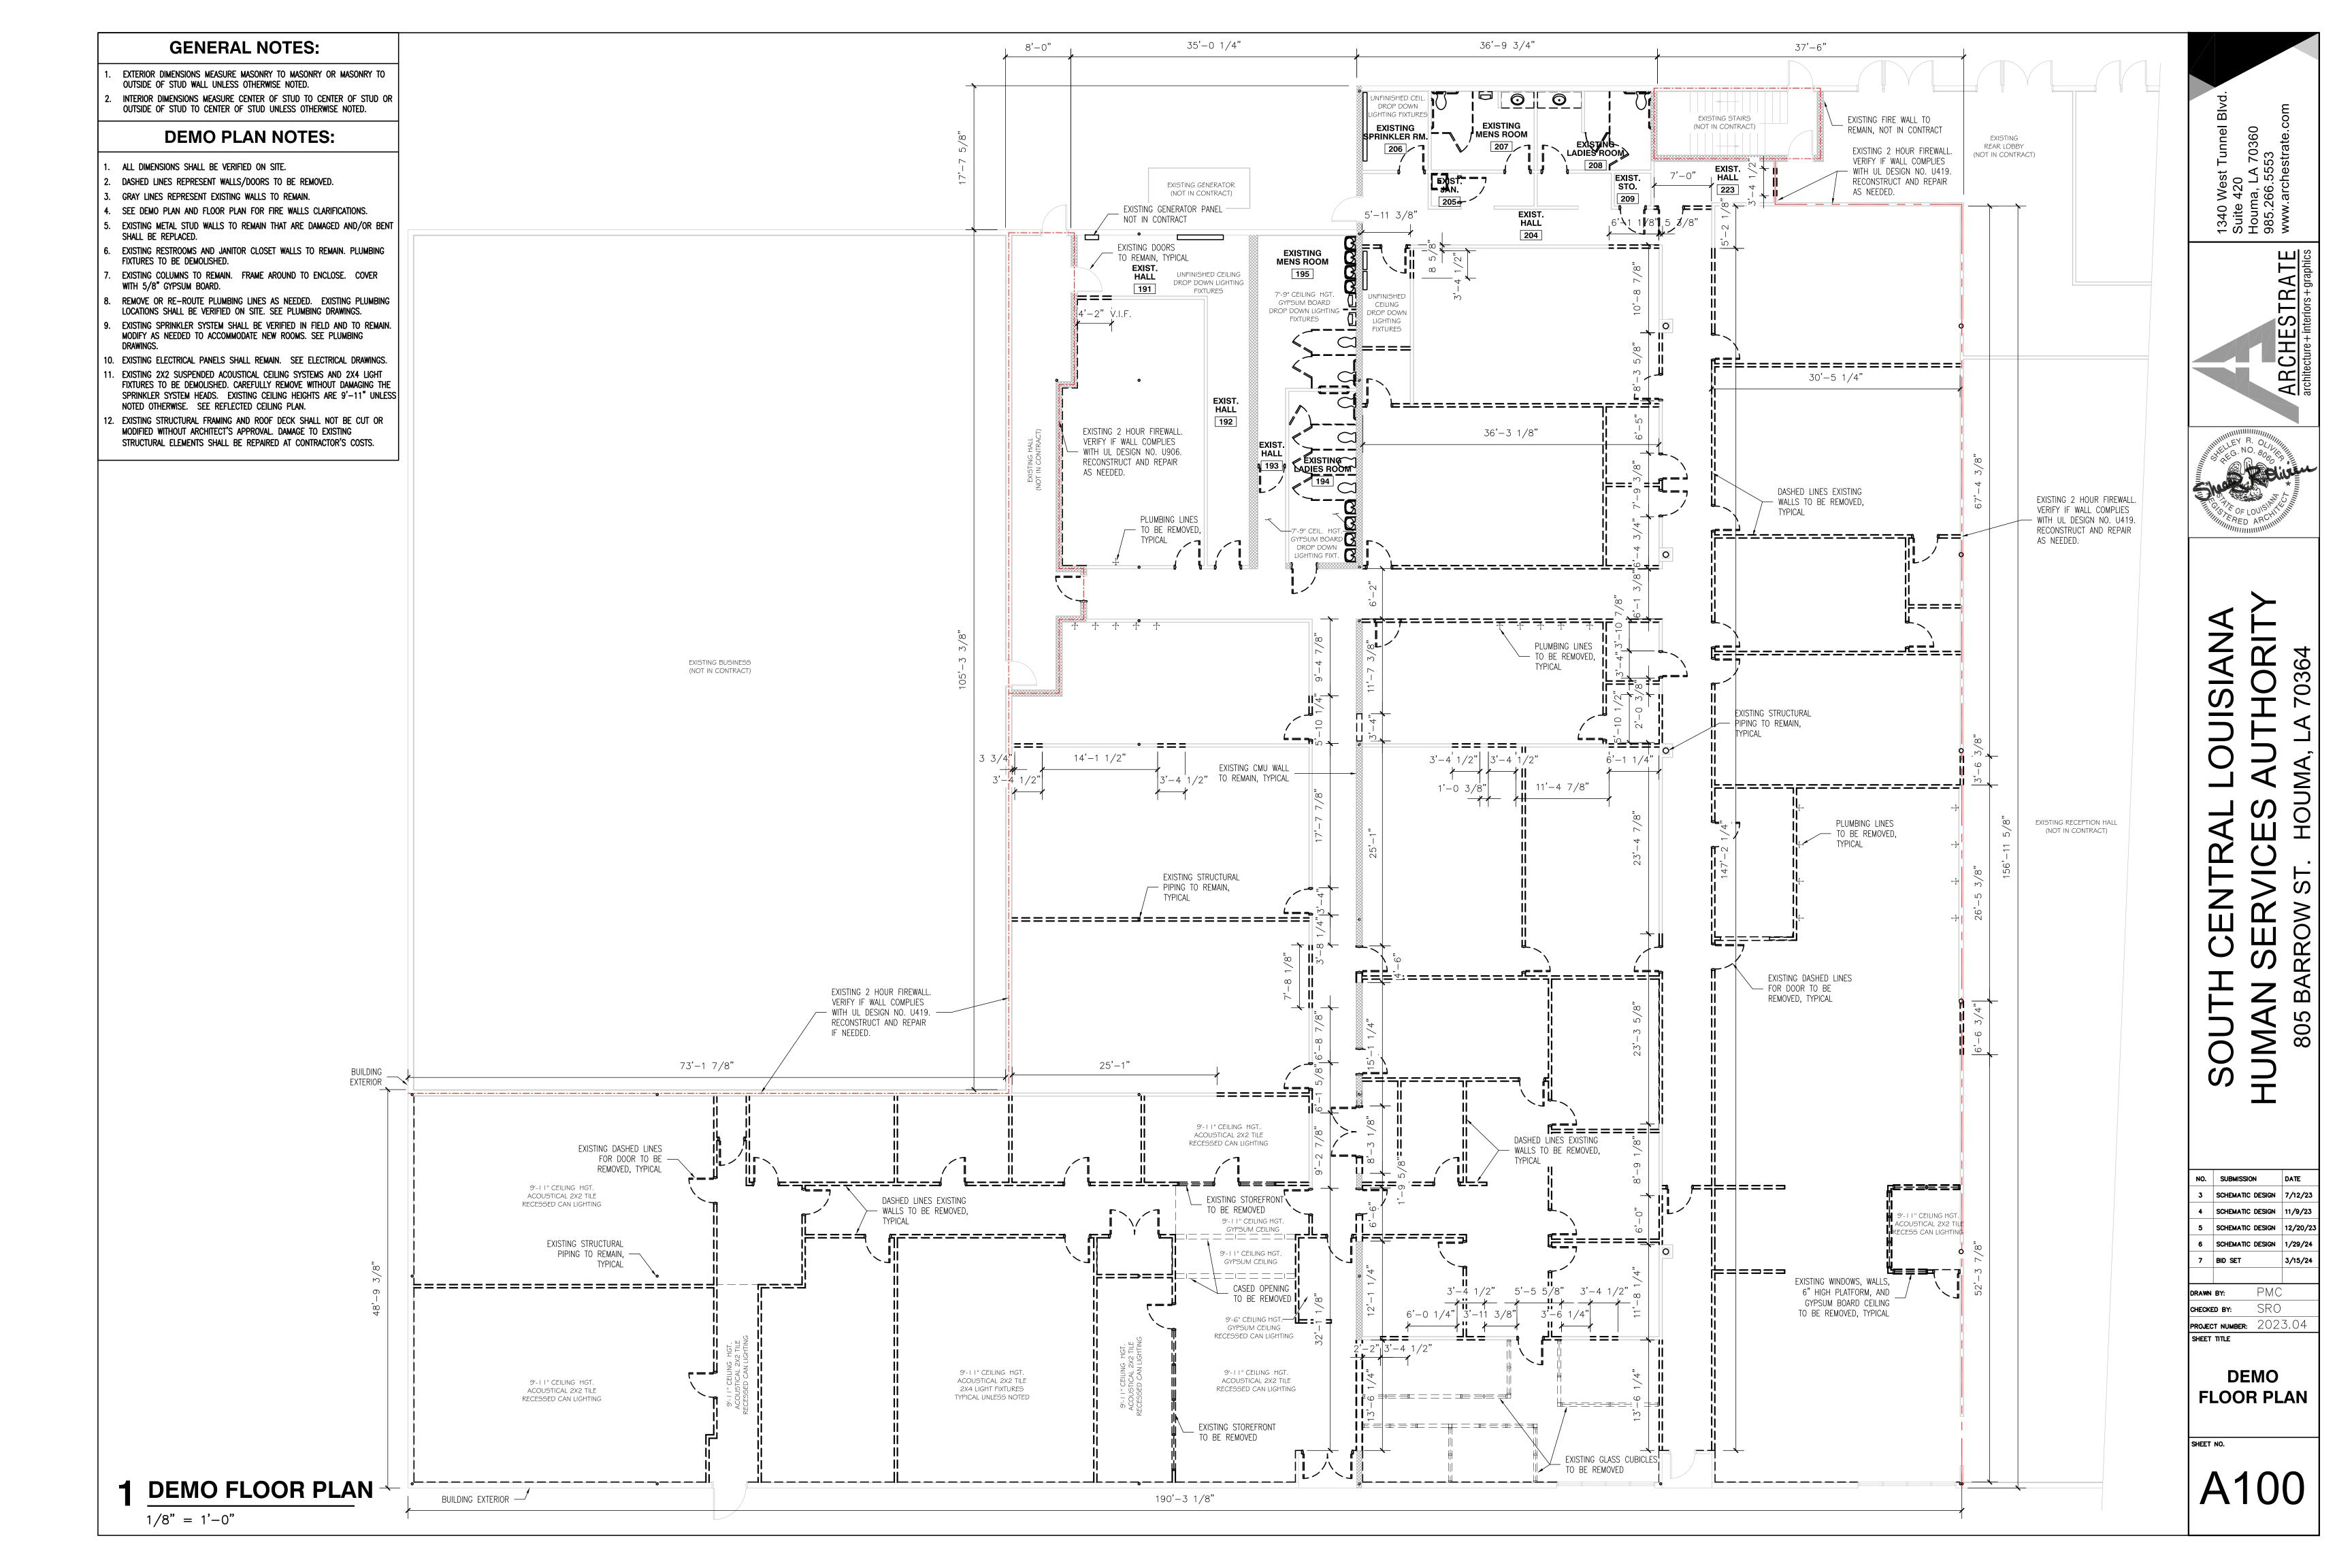


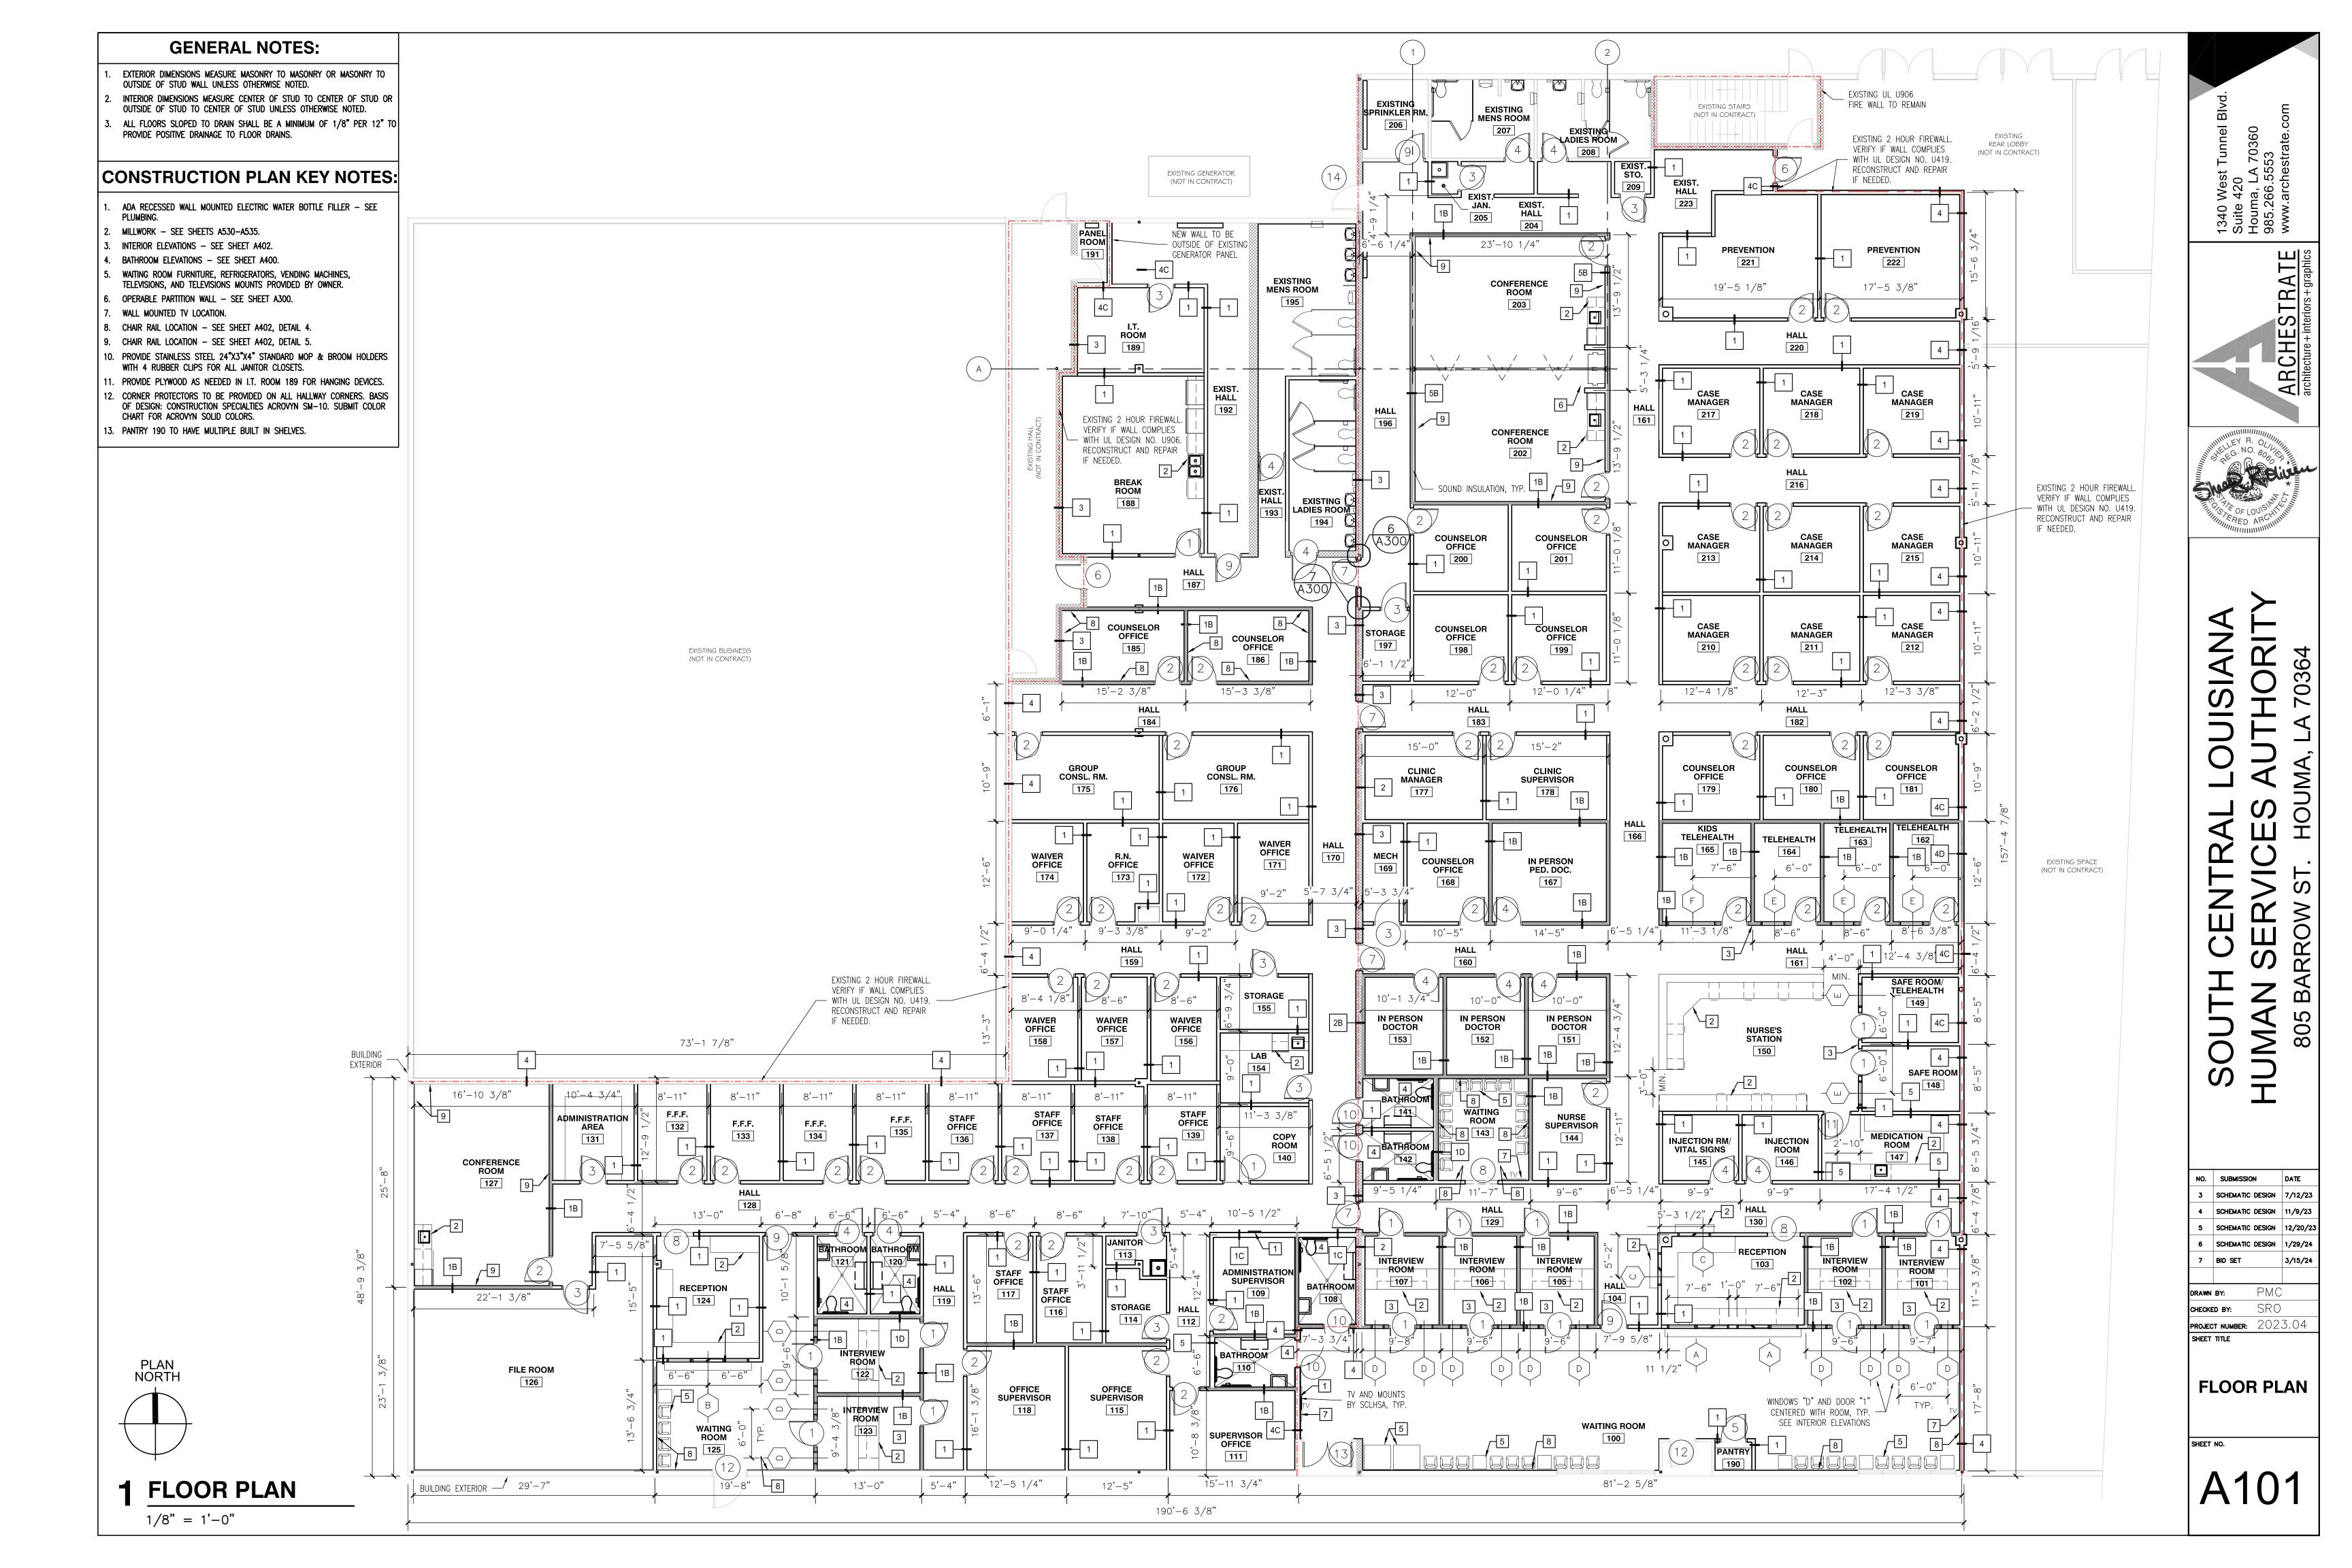

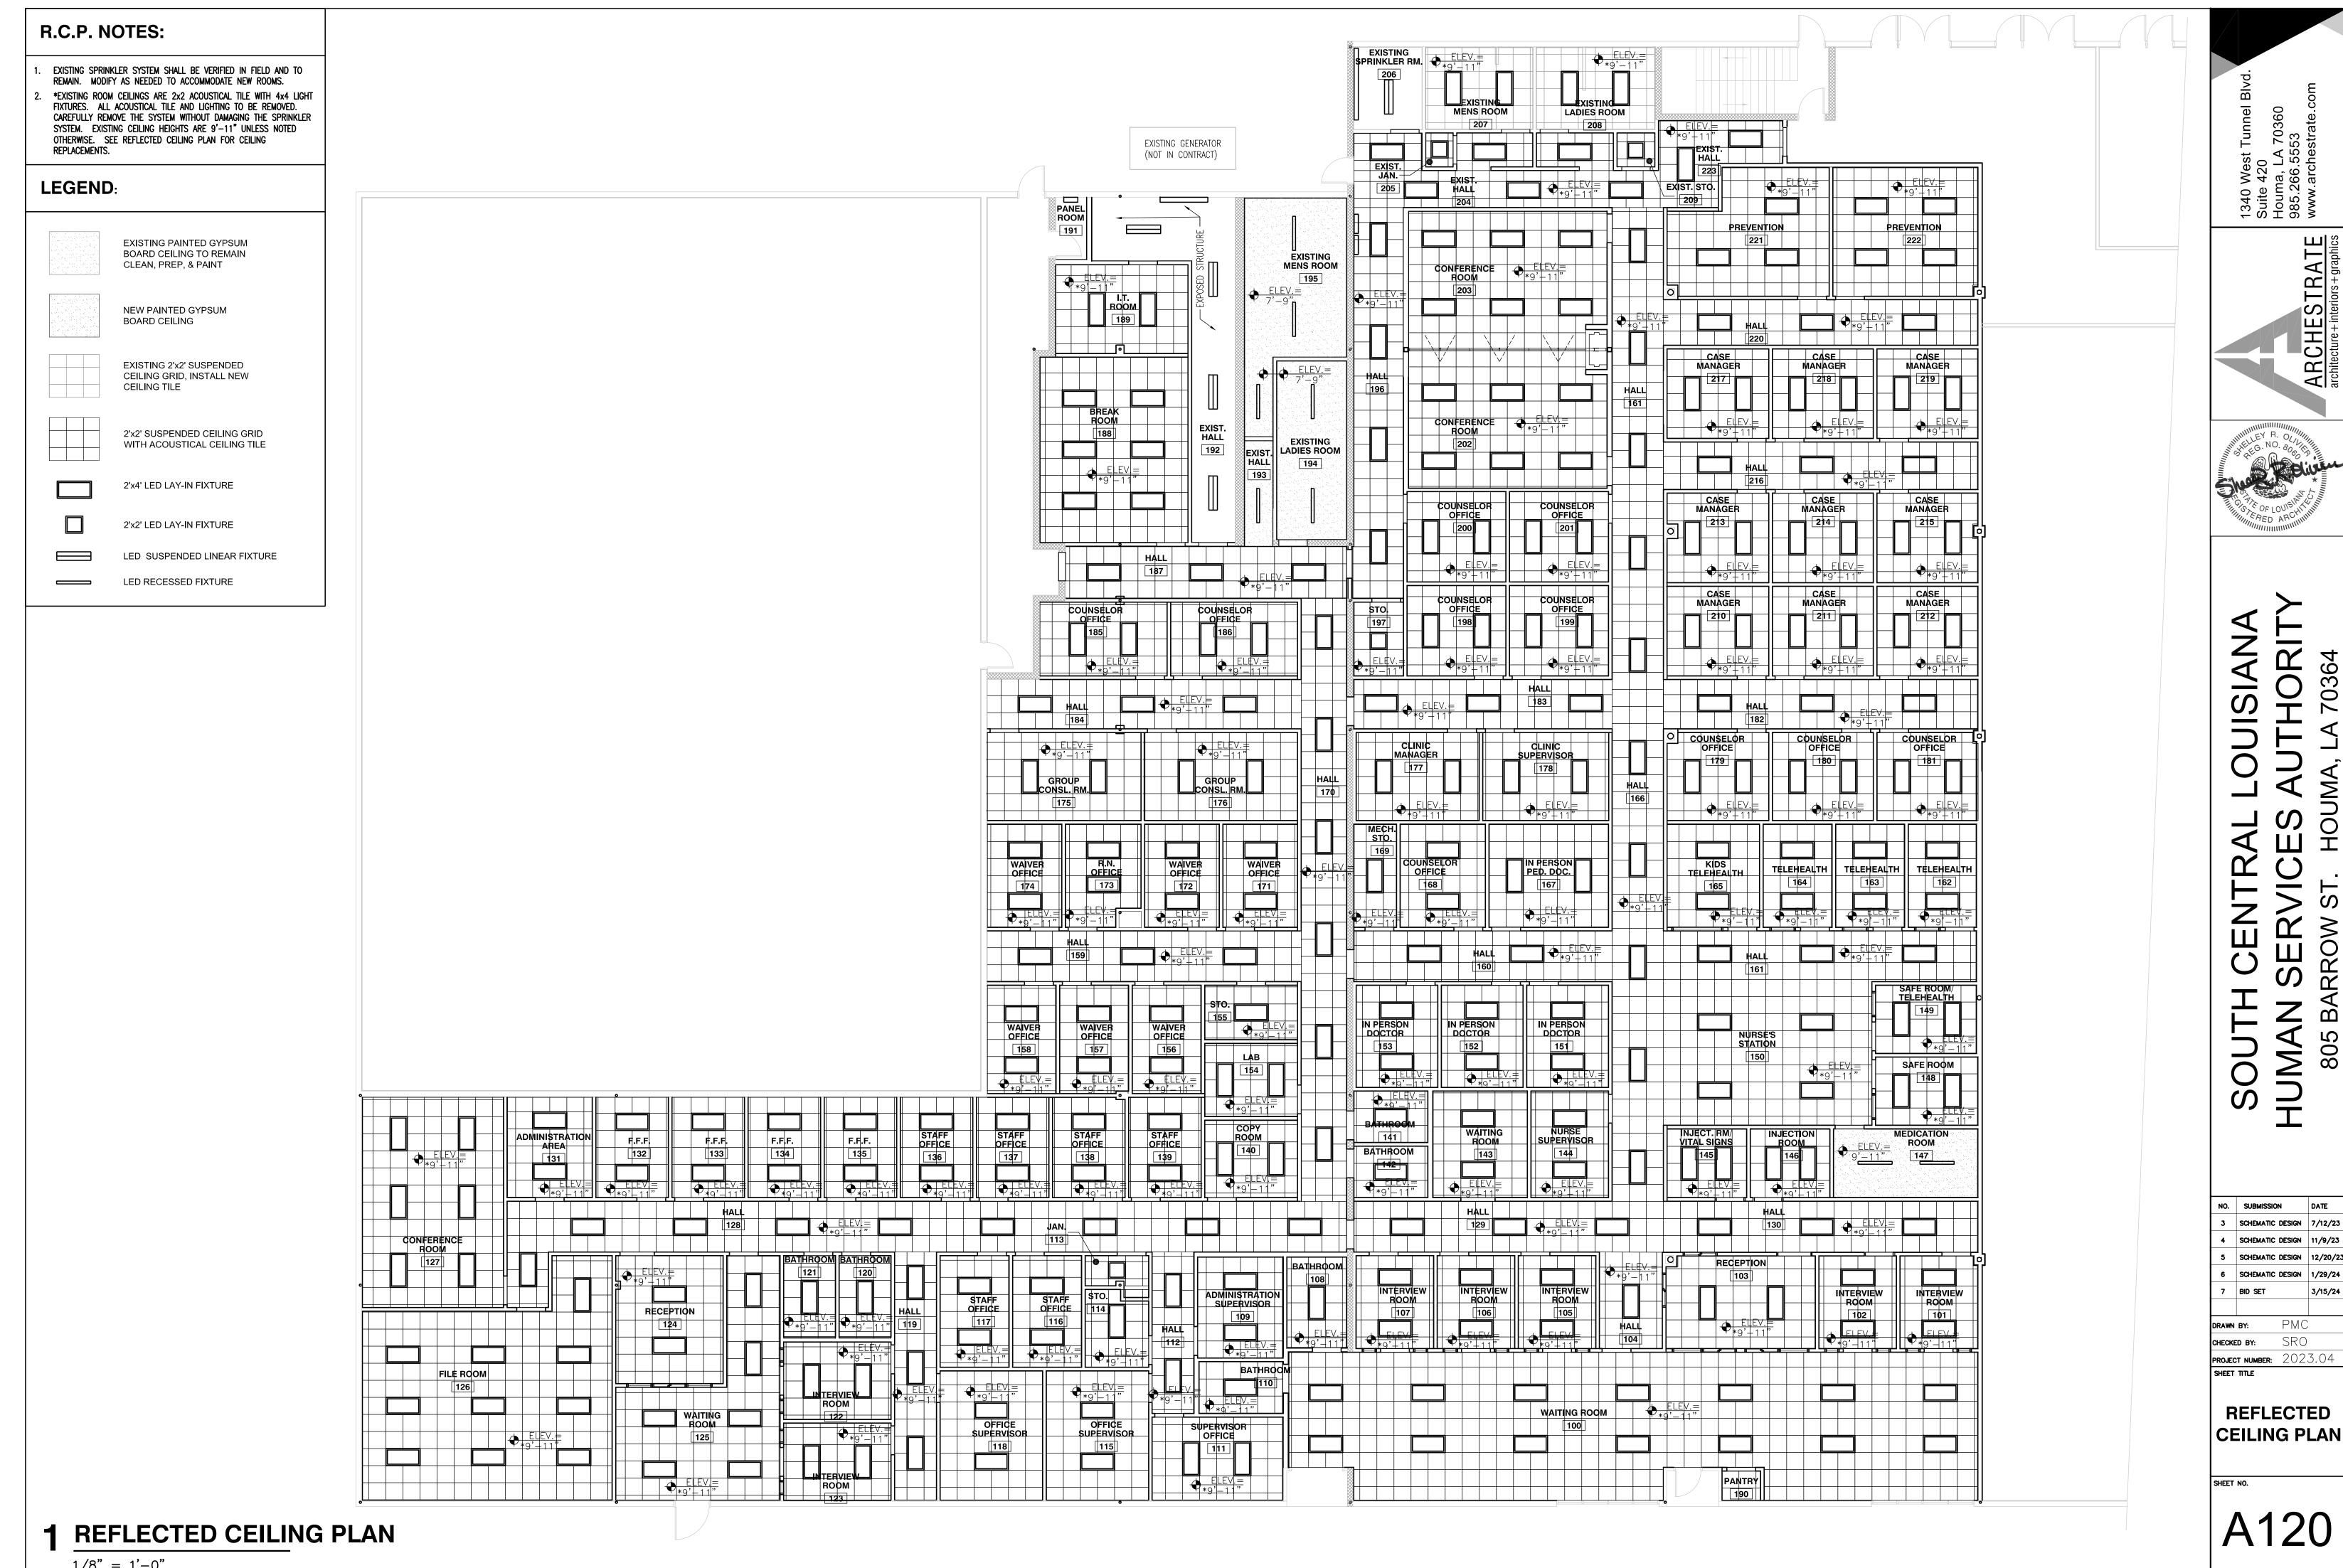1/8" = 1'-0"



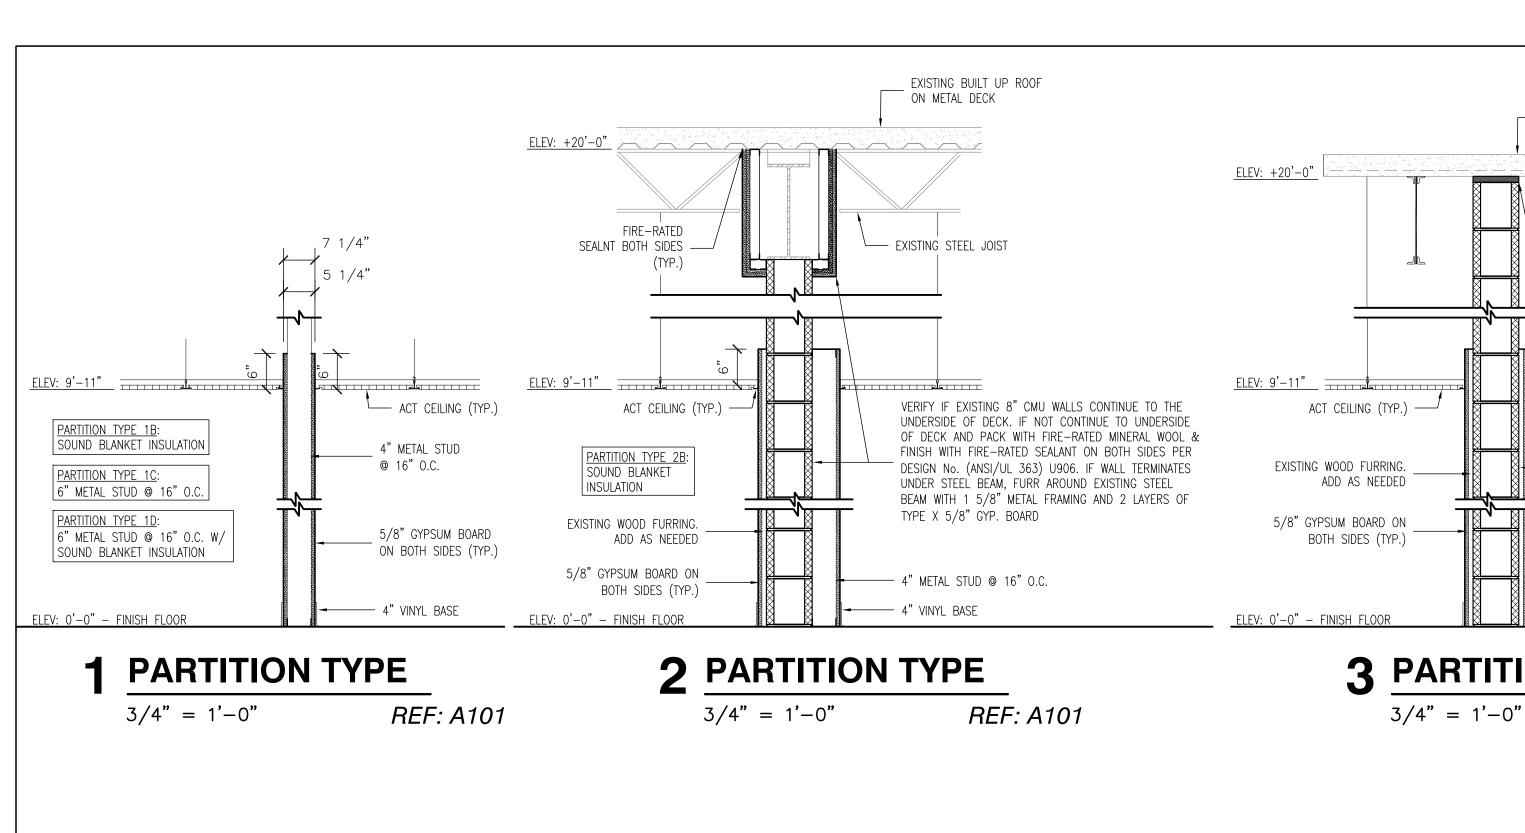

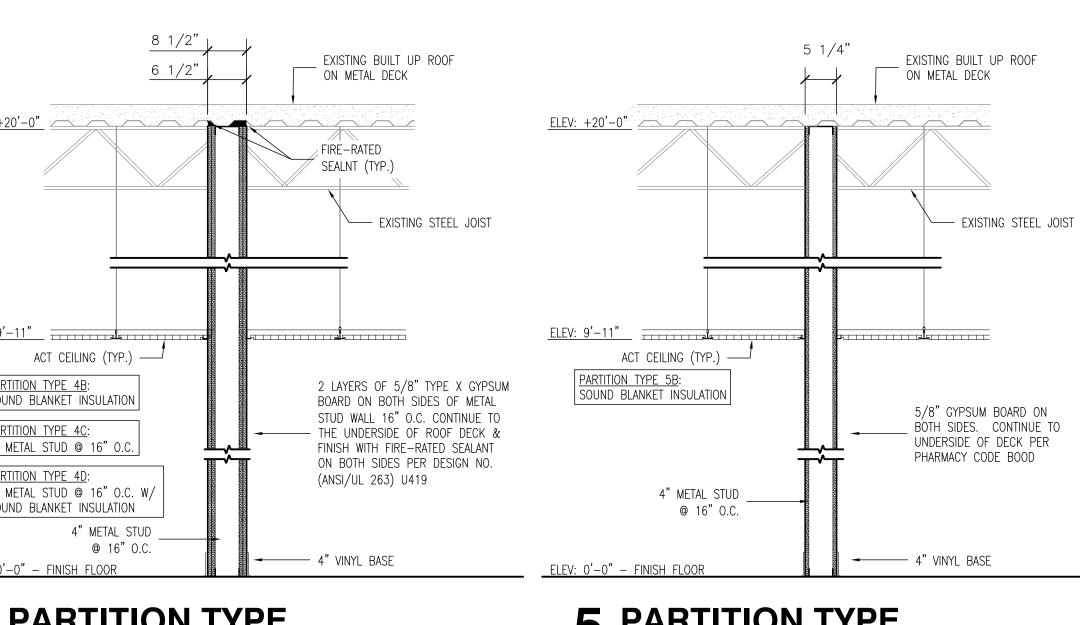



3 PARTITION TYPE


REF: A101


4 PARTITION TYPE

REF: A101 3/4" = 1'-0"

5 PARTITION TYPE

REF: A101 3/4" = 1'-0"

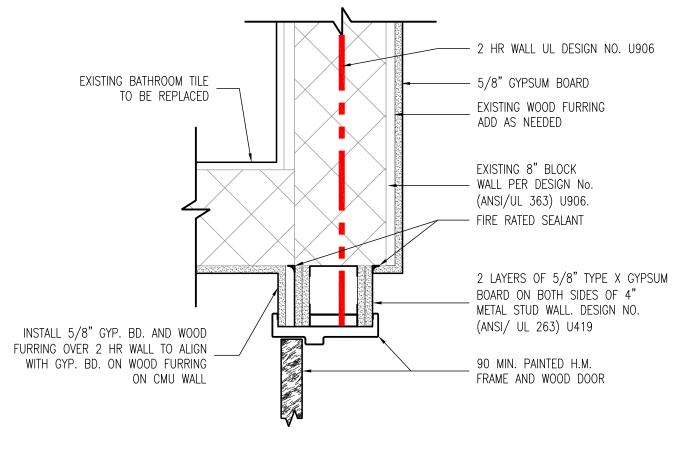

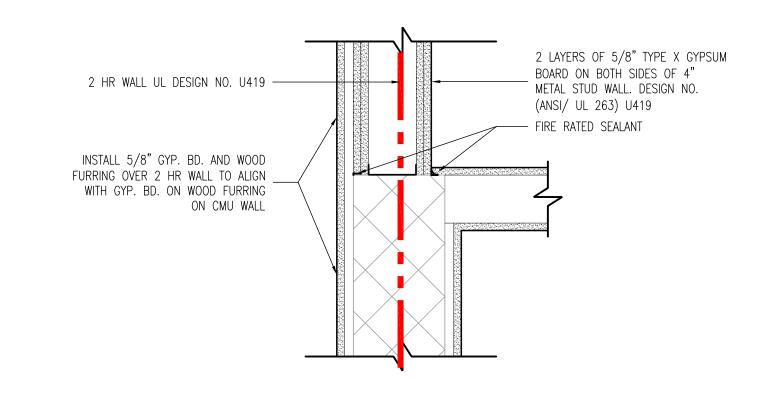

6 WALL DETAIL

1-1/2" = 1'-0"

REF: A101

WALL DETAIL

1-1/2" = 1'-0" REF: A101

GENERAL NOTES:


3 5/8"


3/8" = 1'-0"


1. INSTALL 5/8" CEMENT BACKER BOARD IN LIEU OF 5/8" GYPSUM BOARD IN

RESTROOMS TO RECEIVE TILE AS SPECIFIED.

SEE SHEET A360 FOR LIGHT GAUGE METAL FRAMING DETAILS OF ASTM C754. STUD WALLS SHALL EXTEND TO UNDERSIDE OF DECK OR LATERALLY BE BRACED PER ASTM C754.

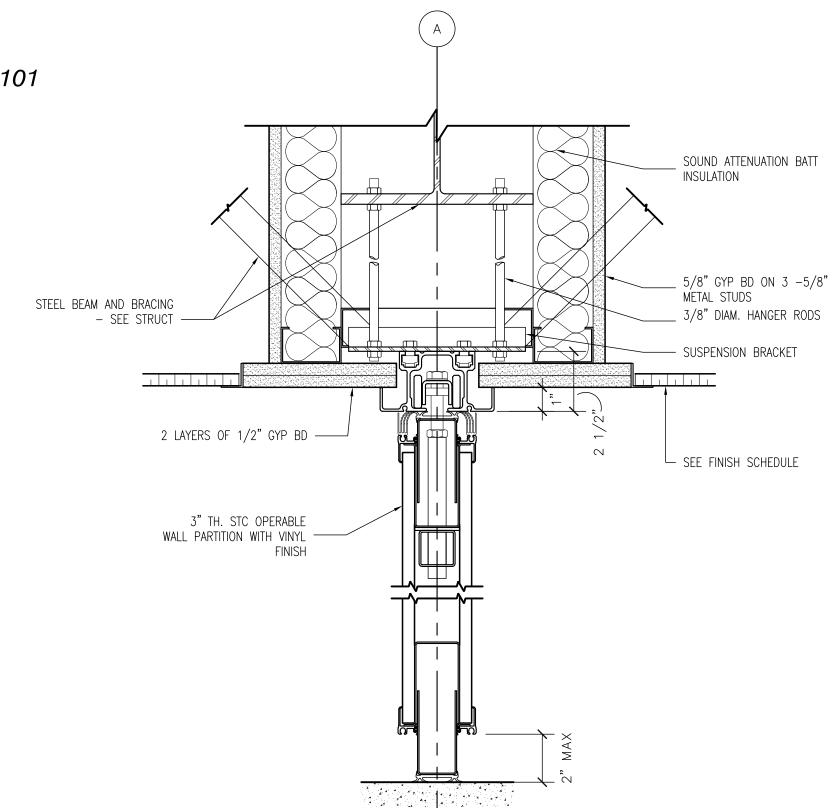

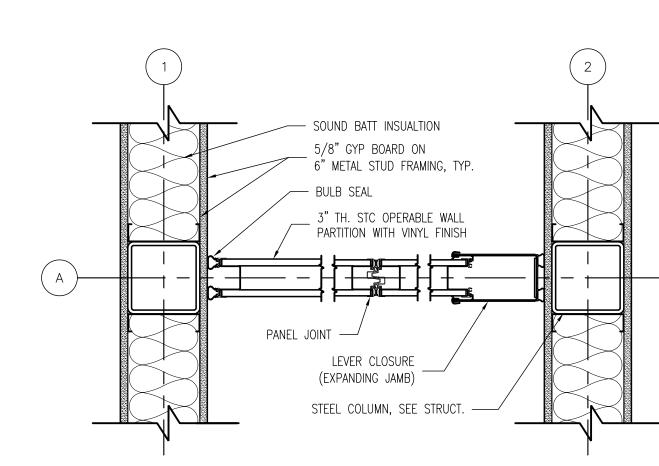

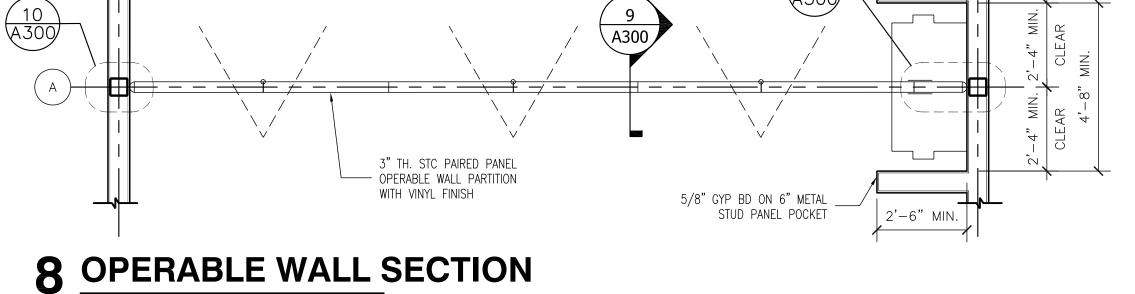

REF: A101

23'-3" (6 EQUAL PANELS) V.I.F.


9 OPERABLE WALL SECTION 3" = 1'-0"REF: A101 10 OPERABLE WALL SECTION $1 \ 1/2" = 1'-0"$ REF: A101

RA CEN SON

PMC SRO PROJECT NUMBER: 2023.04

PARTITION TYPES & **DETAILS**


SHEET TITLE

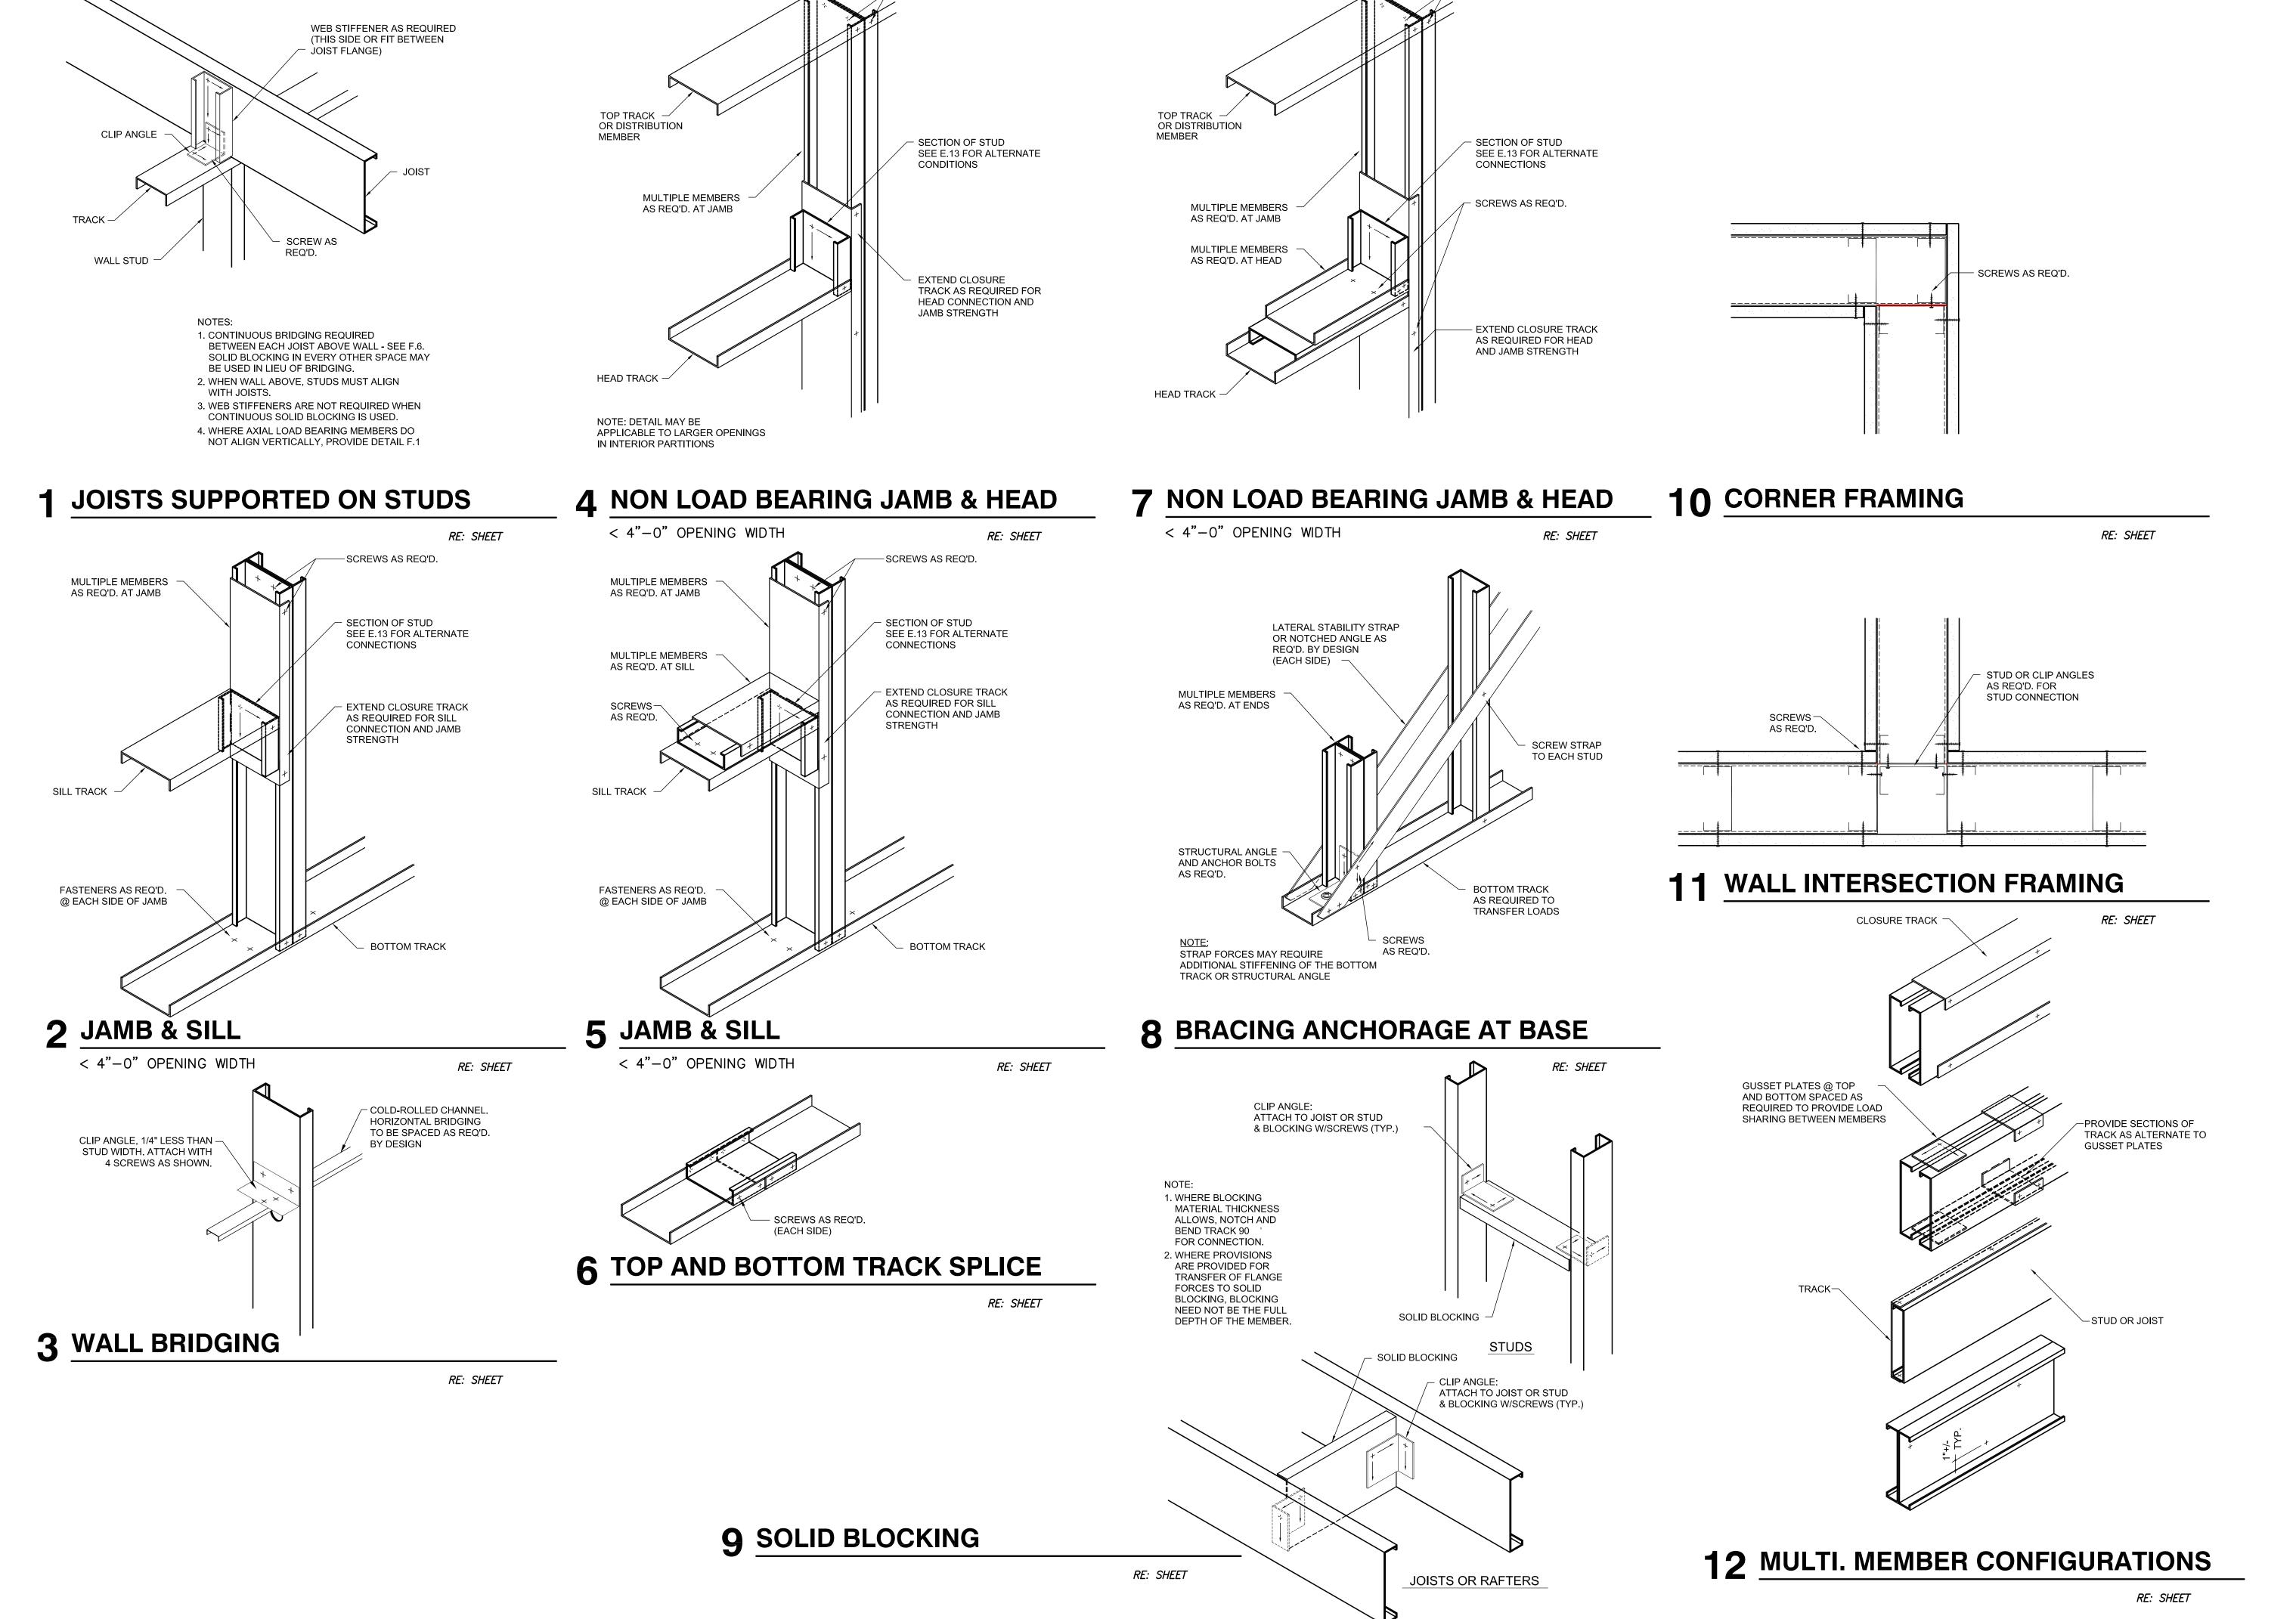

—SCREWS AS REQ'D.

—SCREWS AS REQ'D.



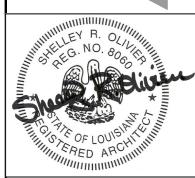

SOU

SCHEMATIC DESIGN 11/9/23


PMC PROJECT NUMBER: 2023.04 SHEET TITLE

LIGHT GAUGE METAL FRAMING

A360


1 TYPICAL ADA RESTROOM LAYOUT

1/4" = 1'-0" REF: A101

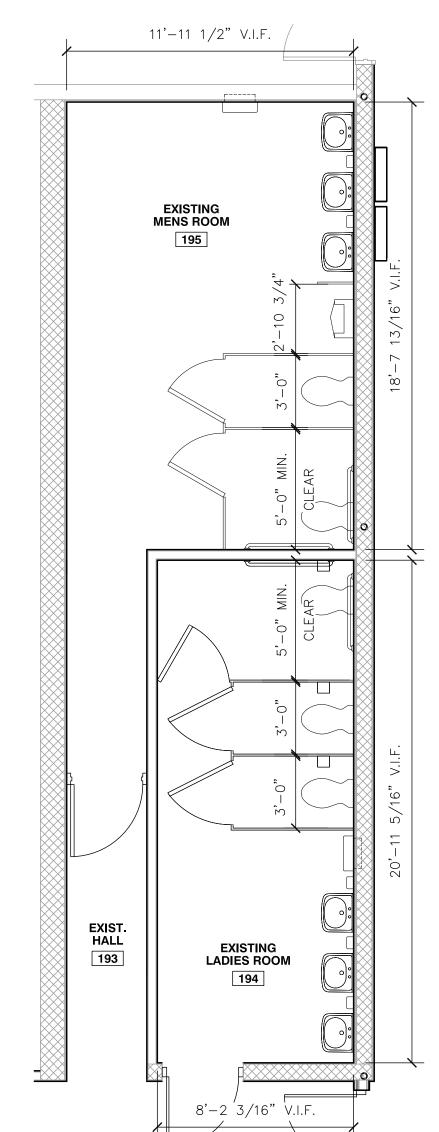


2 EXISTING REMODELED RESTROOMS

1/4" = 1'-0"

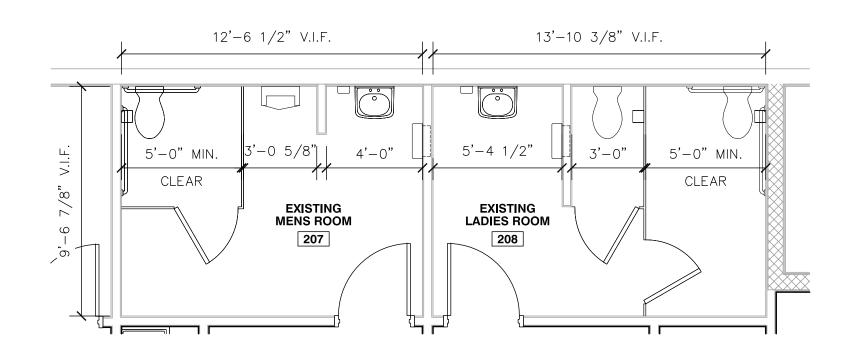

REF: A101

3 EXISTING REMODELED RESTROOMS 1/4" = 1'-0" REF: A101

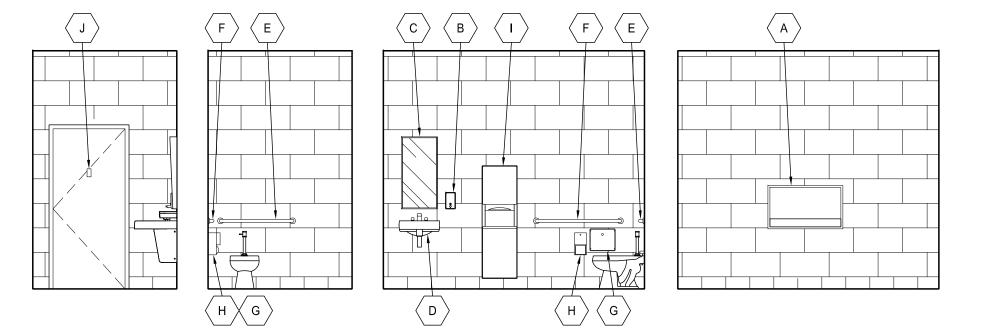

4 TYPICAL ADA WOMAN'S RESTROOM


1/4" = 1'-0"

REF: A400

5 TYPICAL ADA MEN'S RESTROOM


1/4" = 1'-0" REF: A400

D

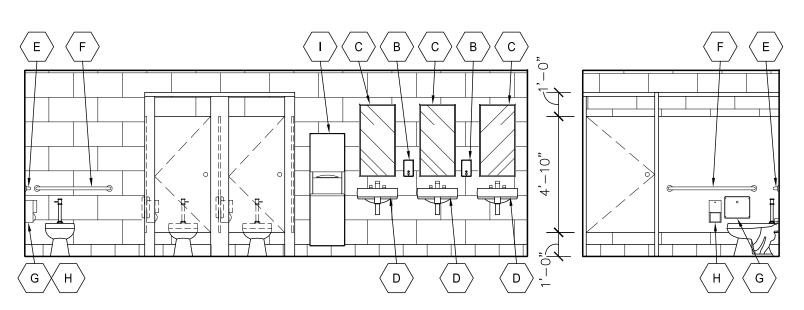

6 TYPICAL EXISTING LADIES RESTROOM 194

1/4" = 1'-0" REF: A400

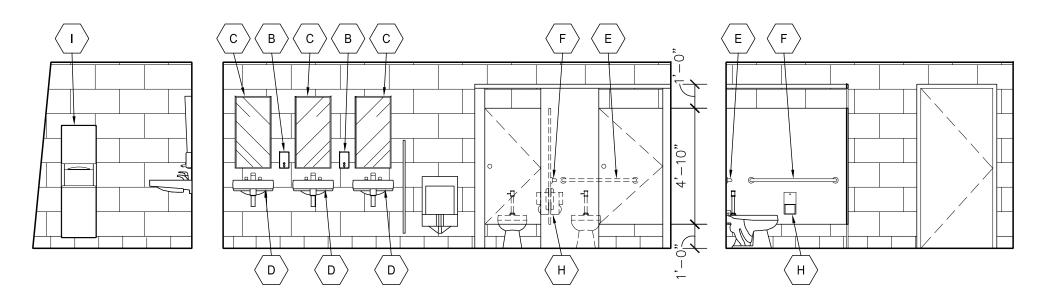


REF: A400

7 TYPICAL EXISING MEN'S RESTROOM 195

1/4" = 1'-0"

8 TYPICAL EXISTING LADIES RESTROOM 206


1/4" = 1'-0" REF: A400

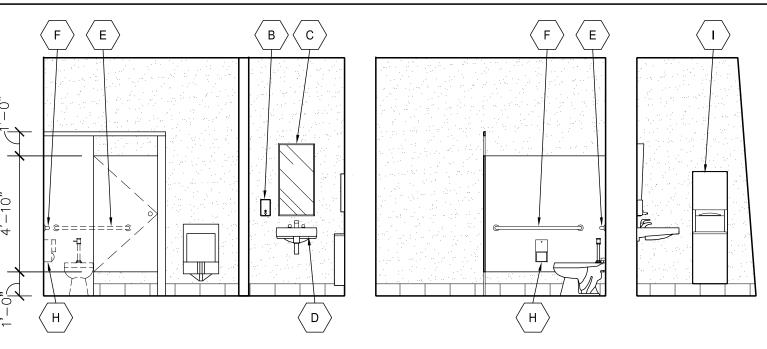


9 TYPICAL EXISTING MEN'S RESTROOM 207

1/4" = 1'-0" REF: A400

SCHEDULE OF TOILET ROOM ACCESSORIES

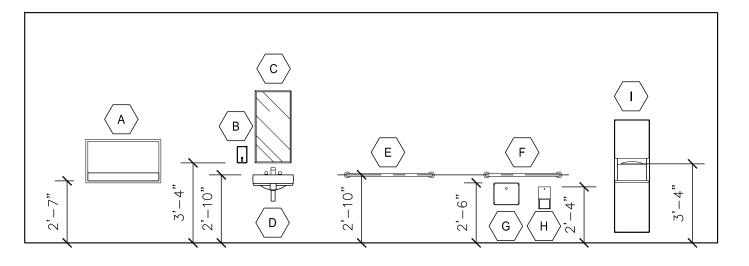

$\left \left\langle \mathbf{A} \right\rangle \right $	BRADLEY BABY CHANGING STATION — MODEL 962—11 (OR SIMILAR)	(E)	GRAB BAR 42"L
В	SOAP DISPENSER — WALL MOUNTED (OWNER FURNISHED, CONTRACTOR INSTALLED)	F	GRAB BAR 36"L
$\langle c \rangle$	MIRROR 18"W x 36"H - WALL MOUNTED	G	NAPKIN DISPOSAL
D	SINK FIXTURE — USE EXISTING SINKS SEE PLUMBING	$\langle H \rangle$	TOILET TISSUE DISPENSER — WALL MOUNTED
	PAPER TOWELS DISPENSER — WALL MOUNTED (OWNER FURNISHED, CONTRACTOR INSTALLED)	J	COAT HOOK

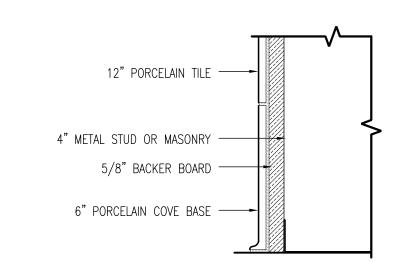

10 TYPICAL PORCELAIN TILE DETAIL 3" = 1'-0" REF: A400

DRAWN BY:

DRAWN BY: PMC
CHECKED BY: SRO
PROJECT NUMBER: 2023.04

RACE

SOUTH HUMAN

ENLARGED ADA PLANS/ RESTROOM ELEVATIONS

EET NO.

A400

GENERAL NOTES

ENTIRE BUILDING SHALL COMPLY WITH THE 2010 ADA-ABA ACCESSIBILITY GUIDELINES:

- 1. FIXTURES WHICH HAVE CLEAR FLOOR SPACES REQUIRED SHALL ACT INDEPENDENTLY AND NOT CROSS REQUIRED CLEAR FLOOR SPACES OF OTHER FIXTURES. CLEAR FLOOR SPACE MAY EXTEND UNDER LAVATORY 19" MAX.
- 2. PROVIDE BARRIER-FREE SIGNAGE AT ALL PUBLIC TOILET ROOM DOORS
- 3. ACCESSIBLE FACILITIES ARE REQUIRED TO BE IDENTIFIED AND MUST USE INTERNATIONAL SYMBOL OF ACCESSIBILITY.
- 4. FIRE EXTINGUISHERS AND CABINETS SHALL BE MOUNTED 36" FROM FINISH FLOOR TO CENTER OF EXTINGUISHER OR CABINET, AND 4'-0" MAX TO TOP OF EXTINGUISHER HANDLE.
- 5. DRINKING FOUNTAINS SHALL BE RECESSED IN THE WALL AND HAVE A CLEAR FLOOR SPACE OF 30" X 48". DRINKING FOUNTAINS SHALL BE ACCESSIBLE TO PERSONS IN A WHEEL CHAIR, AND SHALL BE MOUNTED SO THAT THE SPOUT HEIGHT IS NOT MORE THAN 36" ABOVE THE FINISHED FLOOR. THE DRINKING FOUNTAIN CONSTRUCTION AND DIMENSIONS SHALL BE IN CONFORMANCE WITH THE A.D.A.
- PROVIDE SOLID 2X10 WOOD BLOCKING FOR ALL GRAB BARS, TOILET PARTITIONS, URINAL SCREENS, TOILET ACCESSORIES, VANITY TOPS, COAT RACKS, CABINETS, ETC..

ACCESSIBLE SIGNAGE:

- 1. INTERIOR SIGNAGE SHALL BE LOCATED ADJACENT TO DOOR ON THE LATCH SIDE AND SHALL BE MOUNTED AT A HEIGHT OF 60" FROM THE FINISH FLOOR TO CENTER OF SIGN.
- 2. LETTERS AND NUMBERS ON SIGNS SHALL BE UPPERCASE AND RAISED 1/32" MIN. CHARACTERS OR SYMBOLS SHALL BE AT LEAST 5/8" HIGH, BUT NO HIGHER THAN 2 IN. INDENTED CHARACTERS OR SYMBOLS SHALL HAVE A STROKE WIDTH OF AT LEAST 1/4" SYMBOLS OR PICTOGRAPHS ON SIGNS SHALL BE RAISED OR INDENTED 1/32" MIN.
- RESTROOMS, MECHANICAL ROOMS, AND FIRE EXITS SHALL HAVE SIGNAGE.

LAVATORIES:

- 1. LAVATORIES SHALL HAVE A CLEAR FLOOR SPACE OF 30" X 48", AND A CLEAR HEIGHT OF 29" MIN. TO THE BOTTOM OF THE FIXTURE OR SKIRT BD. THEY SHALL HAVE A CLEAR HEIGHT OF 34" MAX. TO THE RIM OF THE FIXTURE, AND A CLEAR DEPTH OF 11" MIN. UNDER THE FIXTURE EXCLUSIVE OF THE BOWL AND WASTE PIPES.
- 2. THE WATER CONTROL VALVES MUST HAVE LEVER HANDLES.
- 3. INSULATE ALL HOT AND COLD WATER SUPPLY AND DRAIN PIPES.

TOILETS:

TOILET SEATS SHALL BE 17" - 19" ABOVE FINISHED FLOOR.

- 2. THE CENTER OF THE TOILET SHALL BE 18" OFF THE SIDE WALL.
- 3. ACCESSIBLE TOILET COMPARTMENTS SHALL HAVE A MINIMUM CLEAR INSIDE DIMENSION OF 60" SIDE TO SIDE. IF THE DOOR SWINGS OUT, PROVIDE 48" MINIMUM CLEAR SPACE IN FRONT OF THE TOILET BOWL, AND IF THE DOOR SWINGS IN PROVIDE 66" MINIMUM CLEAR SPACE IN FRONT OF THE TOILET BOWL. THE DOOR SHALL HAVE A CLEAR UNOBSTRUCTED OPENING WIDTH OF 32."

GRAB BARS:

- 1. GRAB BARS MUST BE MOUNTED ON ONE SIDE AND REAR WALL AND MUST BE 1 1/2" IN DIAMETER WITH 1 1/2" CLEARANCE FROM WALLS. SUCH GRAB BARS SHALL BE SECURELY FASTENED TO SUPPORT A LOAD OF 250 LBS. MIN. AND HAVE A NON-SLIP SURFACE.
- 2. HORIZONTAL GRAB BAR SHALL BE MOUNTED SUCH THAT THE CENTER OF THE BAR IS MOUNTED 33" 36" ABOVE FINISHED FLOOR.
- 3. THE SIDE WALL GRAB SHALL BE 42" LONG AND START 12" OFF THE BACK WALL.
- THE BACK WALL GRAB SHALL BE 36" LONG MIN. AND START 6" OFF THE SIDE WALL.
 THE VERTICAL GRAB BAR SHALL BE INSTALLED 3" 6" ABOVE THE HORIZONTAL GRAB BAR. IT SHALL BE


A MINIMUM OF 18" LONG AND LOCATED 11" - 13" IN FRONT OF THE WATER CLOSET.


TOILET ROOM ACCESSORIES:

- 1. MIRRORS SHALL BE MOUNTED SO THAT THE BOTTOM OF THE REFLECTIVE SURFACE IS NO MORE THAN 40" ABOVE THE FINISH FLOOR.
- 2. WHERE WALL-MOUNTED TOWEL RACKS, DISPENSERS, WASTE DISPOSAL CONTAINERS, OR SIMILAR APPLIANCES ARE PROVIDED, AT LEAST ONE OF EACH MUST BE MOUNTED SO THAT WORKING HEIGHT IS 40" MAX. ABOVE THE FLOOR, AND SHALL BE FREE OF INTERFERENCE BY GRAB BARS OR OTHER APPLIANCES OR FIXTURES.
- 3. TOILET PAPER DISPENSERS SHALL BE INSTALLED BETWEEN 7" 9" IN FRONT OF THE WATER CLOSET. IT SHALL BE MOUNTED SUCH THAT THE OUTLET IS BETWEEN 15" AND 48" ABOVE FINISHED FLOOR WITH A CLEARANCE OF 2" MIN. BELOW OR 12" MIN. ABOVE GRAB BAR.
- COAT HOOKS TO BE ON THE INSIDE OF BATHROOM PARTITION DOOR IN EMPLOYEE RESTROOMS.

CUSTOMER COUNTER:

1. AT COUNTERS AT WHICH GOODS OR SERVICES ARE SOLD OR DISTRIBUTED A PORTION OF THE MAIN COUNTER WHICH IS A MINIMUM OF 36" IN LENGTH SHALL BE PROVIDED WITH A MAXIMUM HEIGHT OF

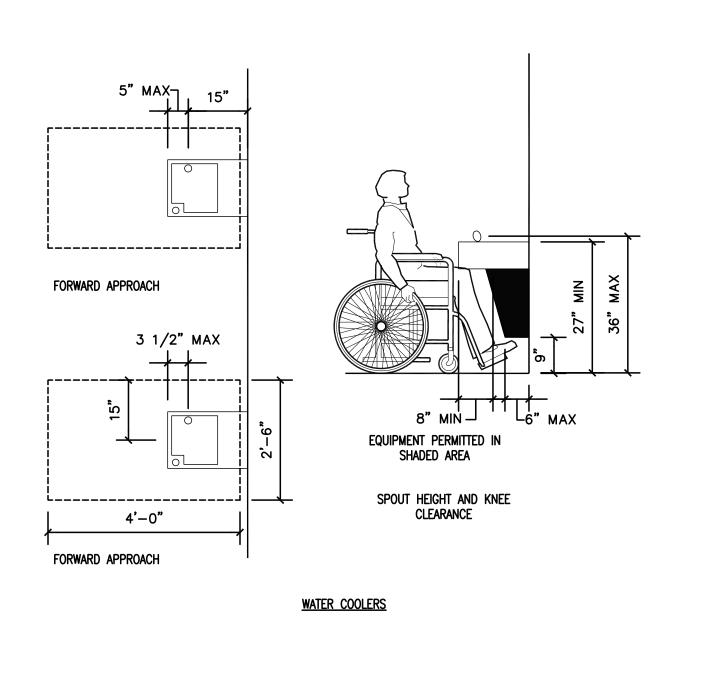

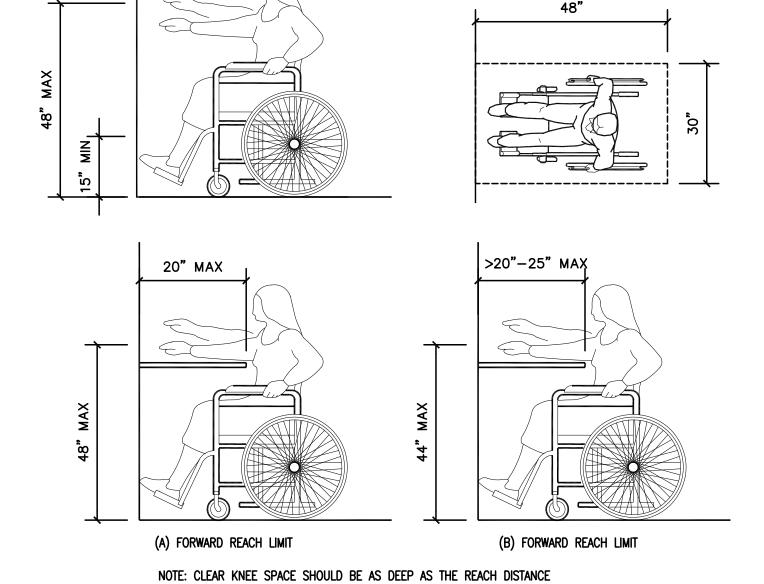

36" GRAB BAR

36" MIN

6"

92" STAB BAR


12' 42" MIN

12' TOILET PAPER DISPENSER


NALL


18"

SIDE WALL

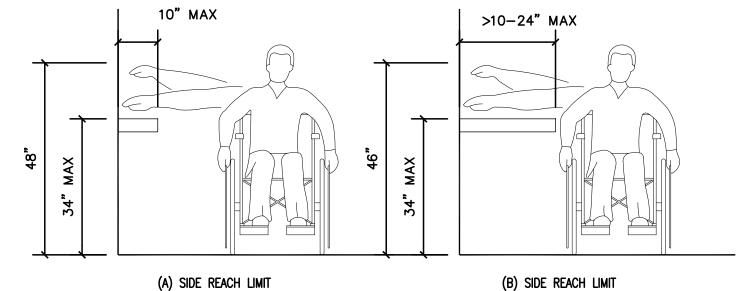

(30"x48" CLEAR FLOOR SPACE REQUIRED)

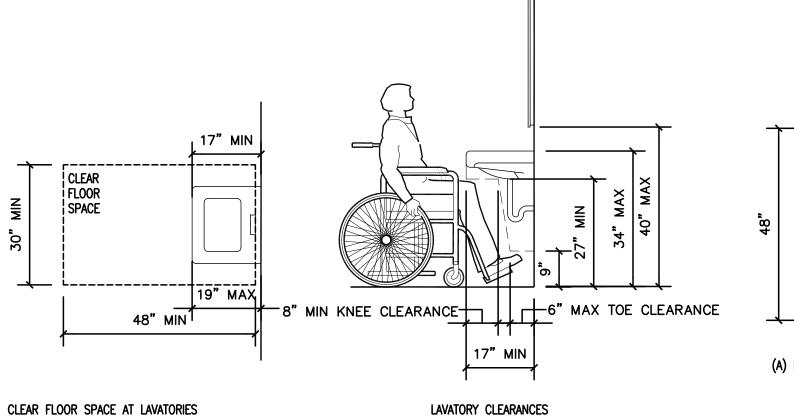

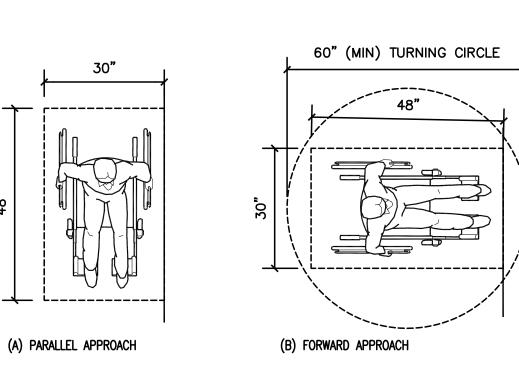


REACH DIMENSIONS OVER AN OBSTRUCTION

<u>LAVATORIES</u>

WATER CLOSETS

MINIMUM CLEAR FLOOR SPACE FOR WHEELCHAIRS

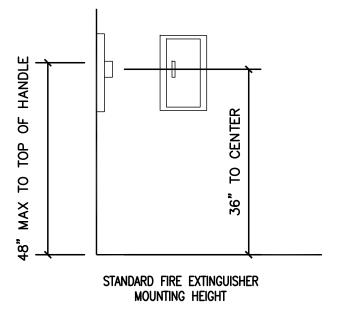

<u>FIRE EXTINGUISHERS</u>

1340 West Tunnel Blvd. Suite 420 Houma, LA 70360 985.266.5553 www.archestrate.com





SOUTH CENTRAL LOUISIANA
HUMAN SERVICES AUTHORITY
805 BARROW ST. HOUMA, LA 70364

NO. SUBMISSION DATE

3 SCHEMATIC DESIGN 7/12/23

4 SCHEMATIC DESIGN 11/9/23

5 SCHEMATIC DESIGN 12/20/23
6 SCHEMATIC DESIGN 1/29/24
7 RID SET 3/15/24

DRAWN BY: PMC

CHECKED BY: SRO

PROJECT NUMBER: 2023.04

ADA DETAH

ADA DETAILS


SHEET NO.

SHEET TITLE

A401





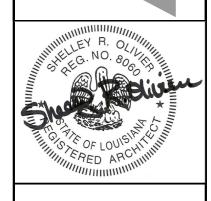

CENTRAL LOUISIANA
SERVICES AUTHORITY
ROW ST. HOUMA, LA 70364

NO. SUBMISSION DATE

3 SCHEMATIC DESIGN 7/12/23

4 SCHEMATIC DESIGN 11/9/23

5 SCHEMATIC DESIGN 12/20/2

6 SCHEMATIC DESIGN 1/29/24

SOUTH

7 BID SET 3/15/2

CHECKED BY: SRO


PROJECT NUMBER: 2023.04

SHEET TITLE

INTERIOR ELEVATIONS

EET NO.

A402

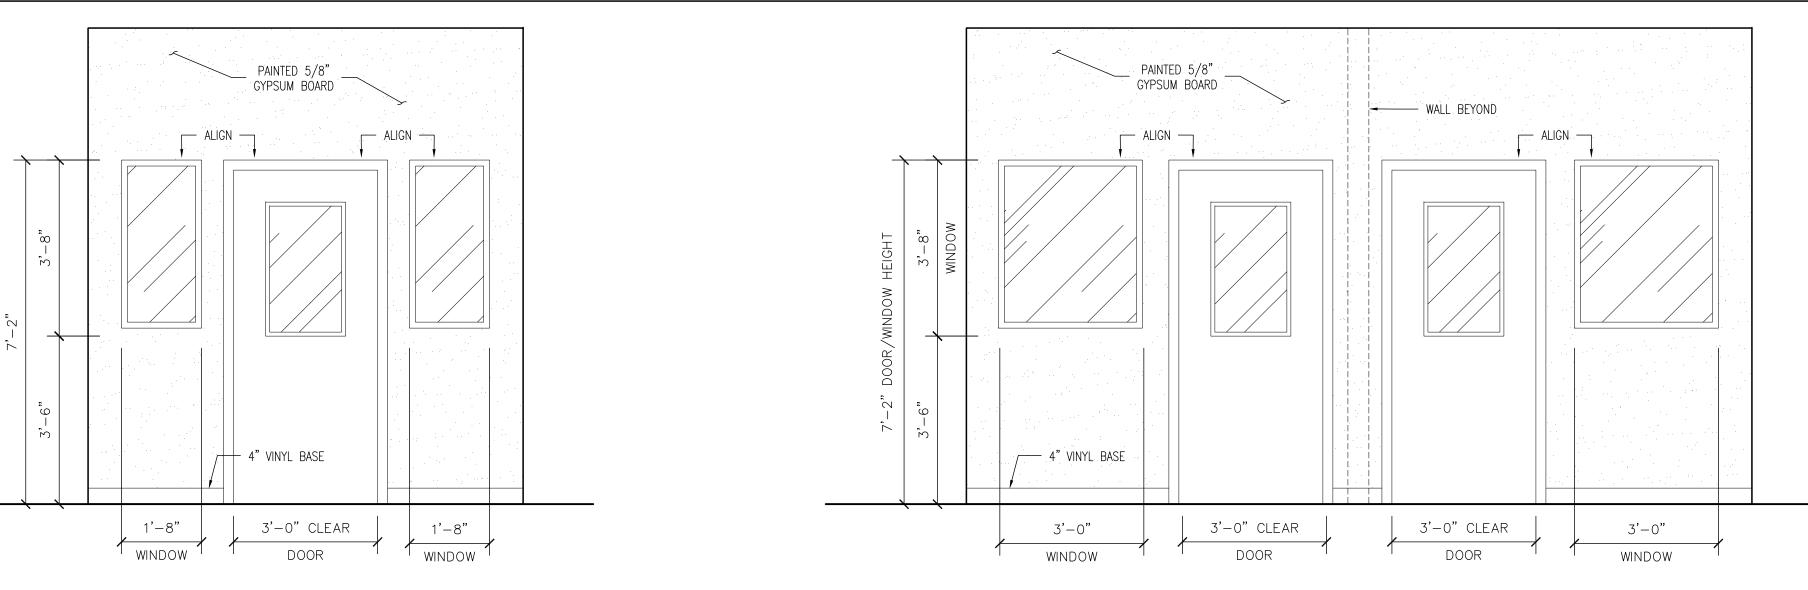


1 INTERVIEW ROOM 101-102, 105-107

1/2" = 1'-0"

REF: A101


2 SAFE ROOM 148-149

1/2" = 1'-0" REF: A101

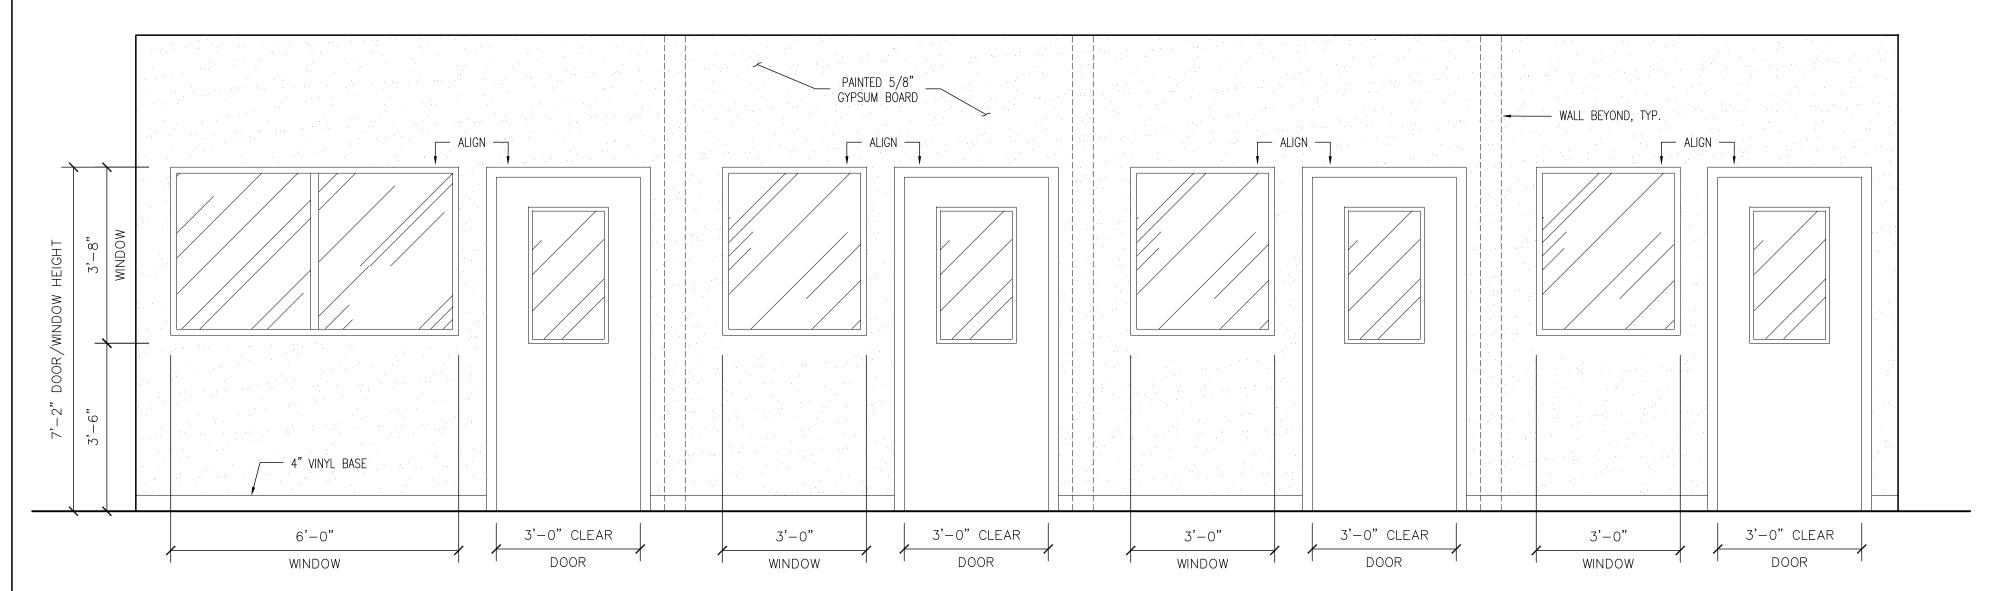

3 TELEHEALTH ROOMS 162-165

1/2" = 1'-0" REF: A101

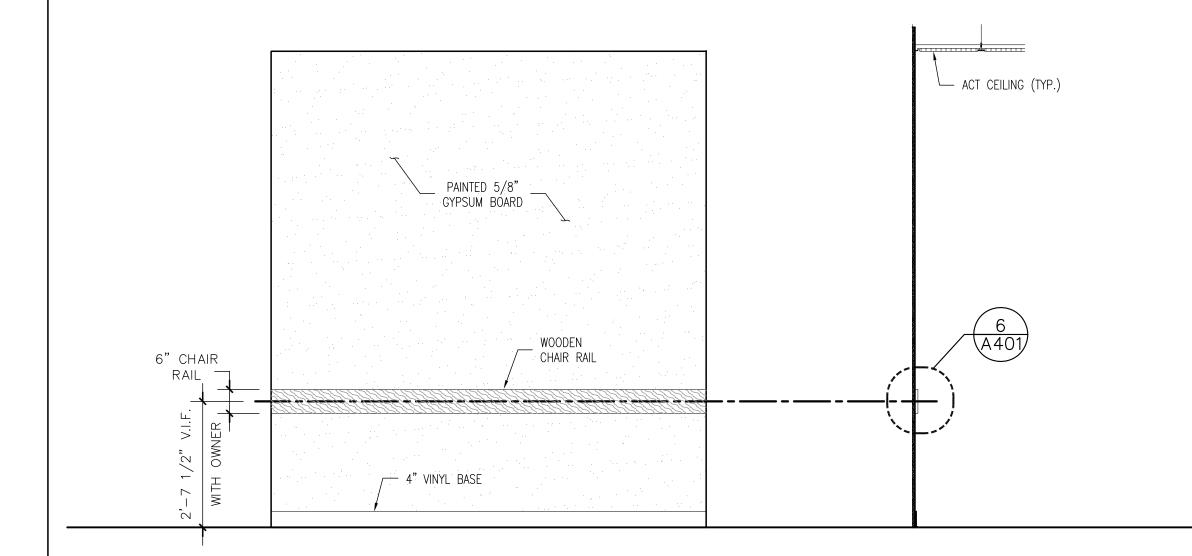

FAINTED 5/8"
GYPSIM BOARD

FOR CHAIR RAIL

RAIL

AT VINYL BASE

4" VINYL BASE

6 CHAIR RAIL DETAIL

3" = 1'-0"

REF: A401

1/2" CHAMFER
TOP AND BOTTOM

MIN. 20 GA. – HORIZONTAL STEEL STUD & STRAPPING

- FASTENERS 16"O.C. MAX.

MAPLE WOOD CHAIR

RAIL SEALED TO
MATCH DOOR COLOR


4 CHAIR RAIL DETAIL - WAITING ROOM 100, 125, 143, & GROUP COUNSELOR ROOM 175-176


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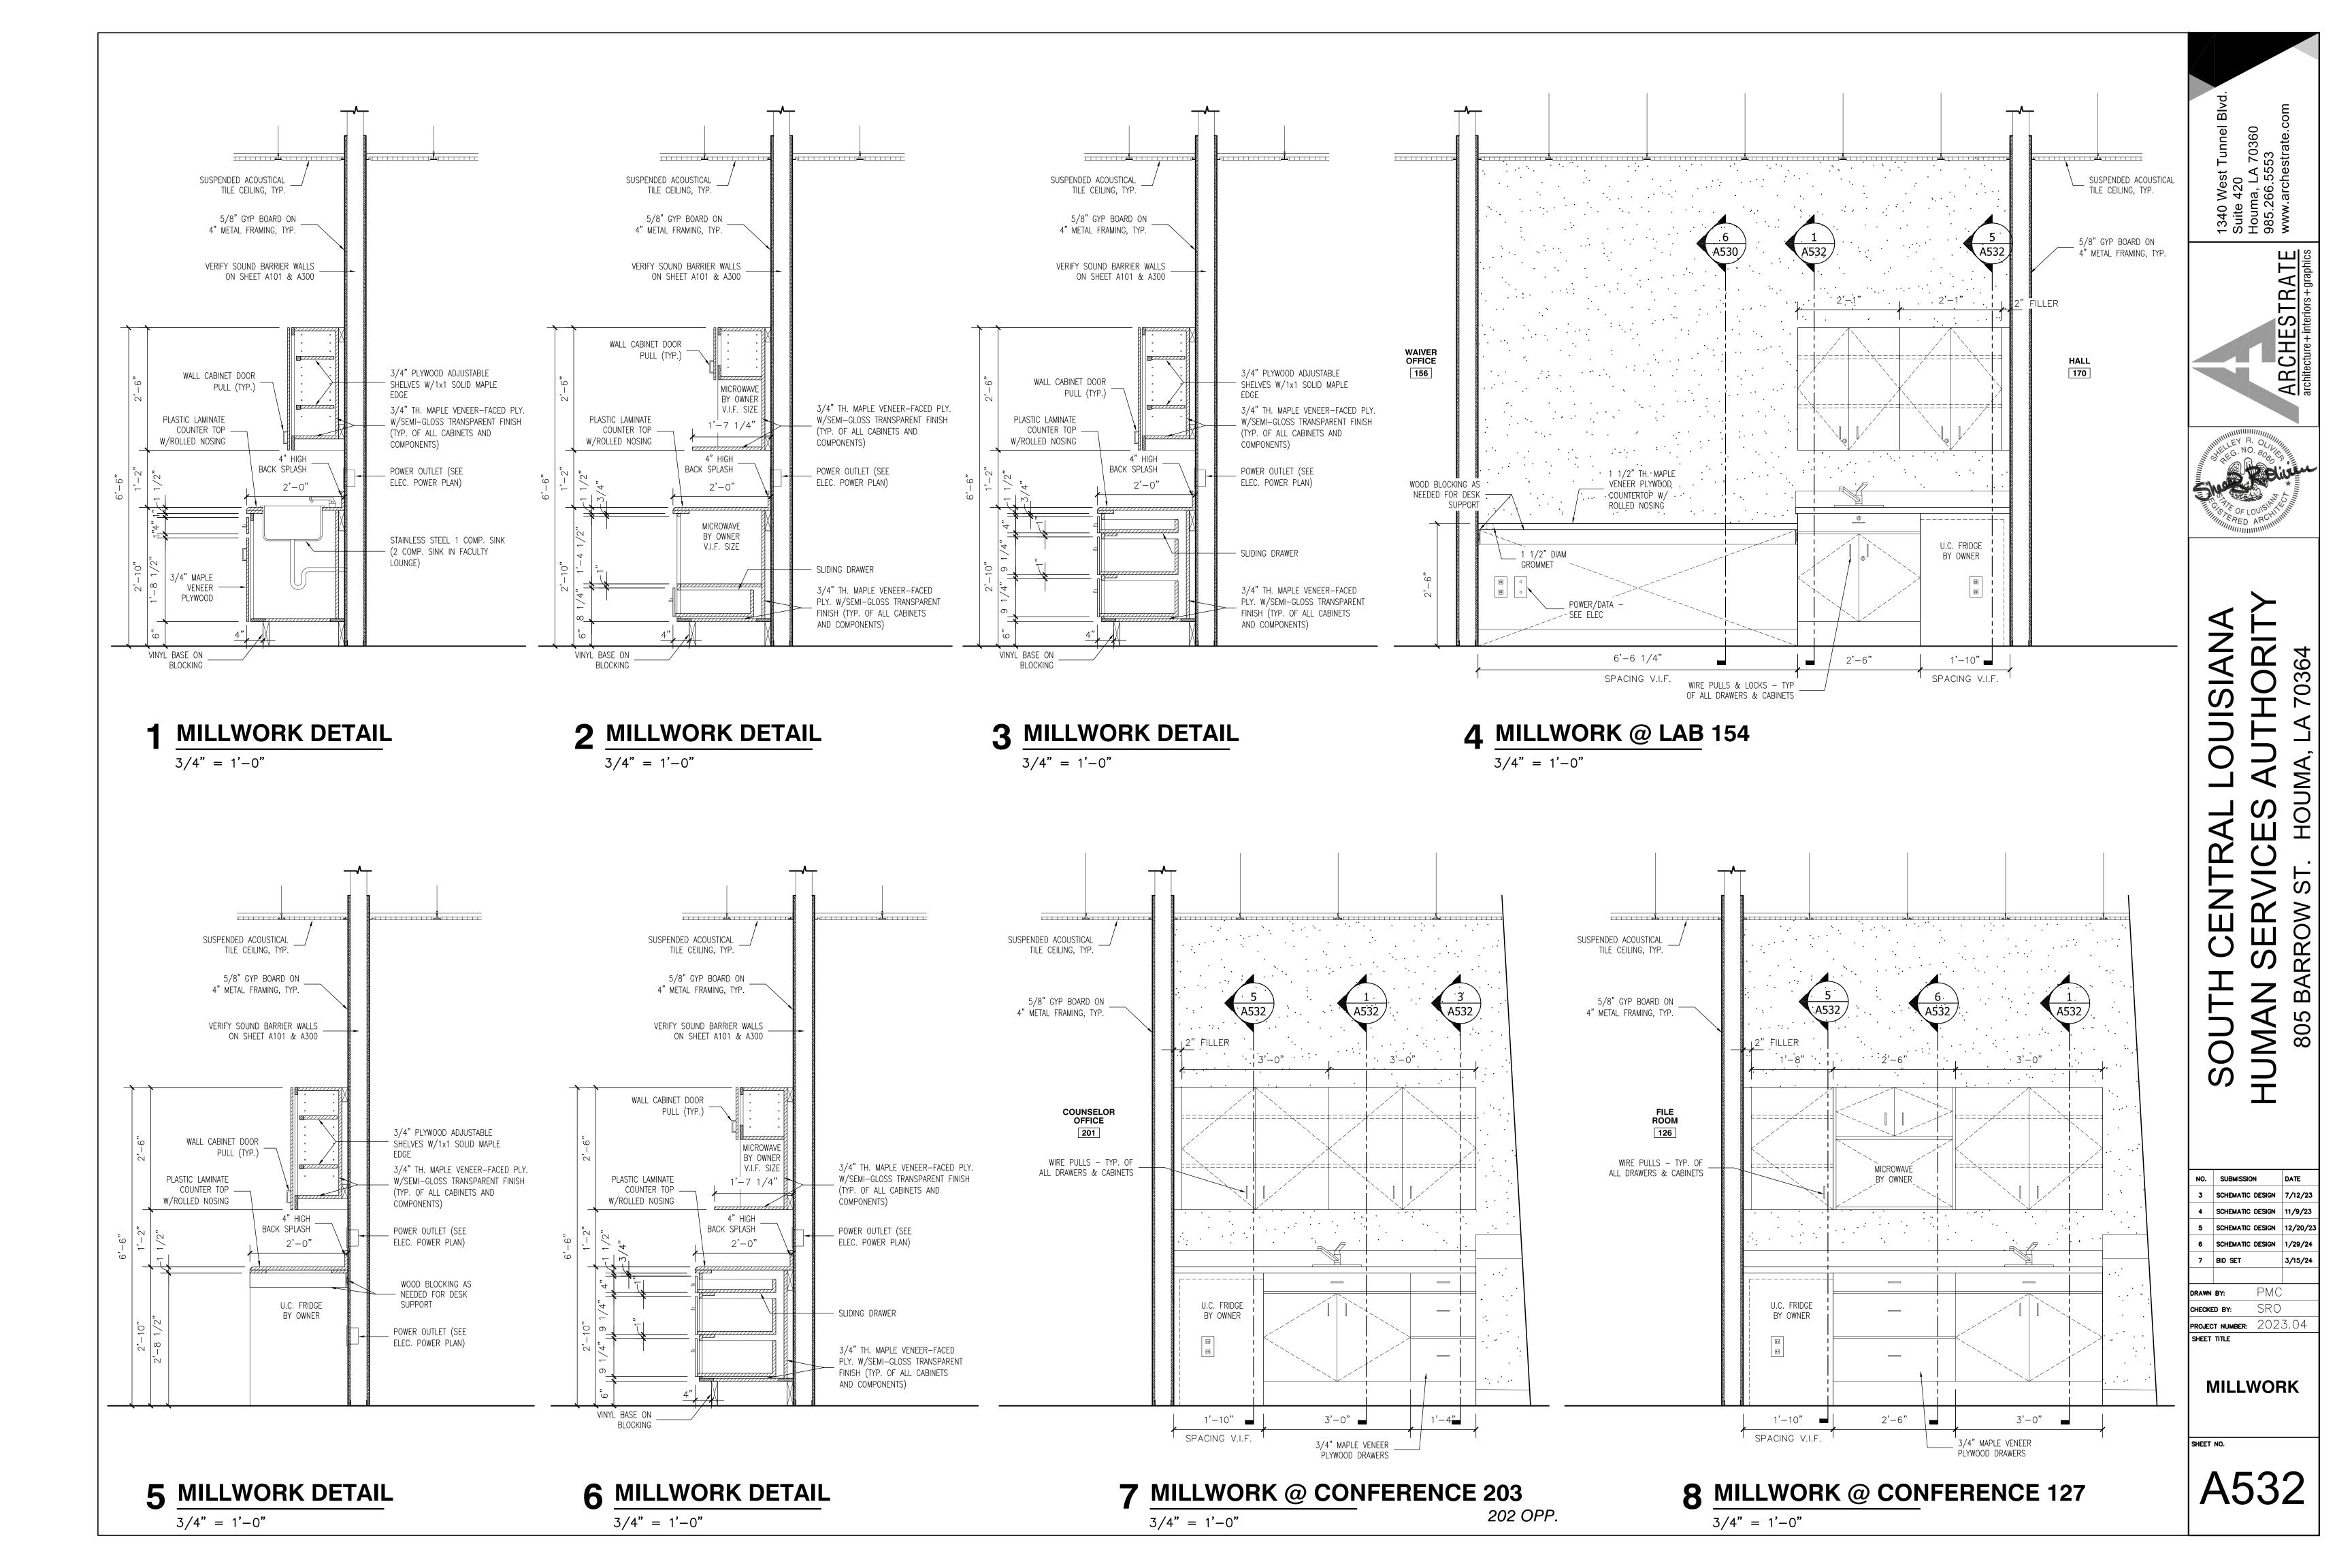
5 CHAIR RAIL DETAIL - CONFERENCE ROOM 127, 202, & 203


1/2" = 1'-0"


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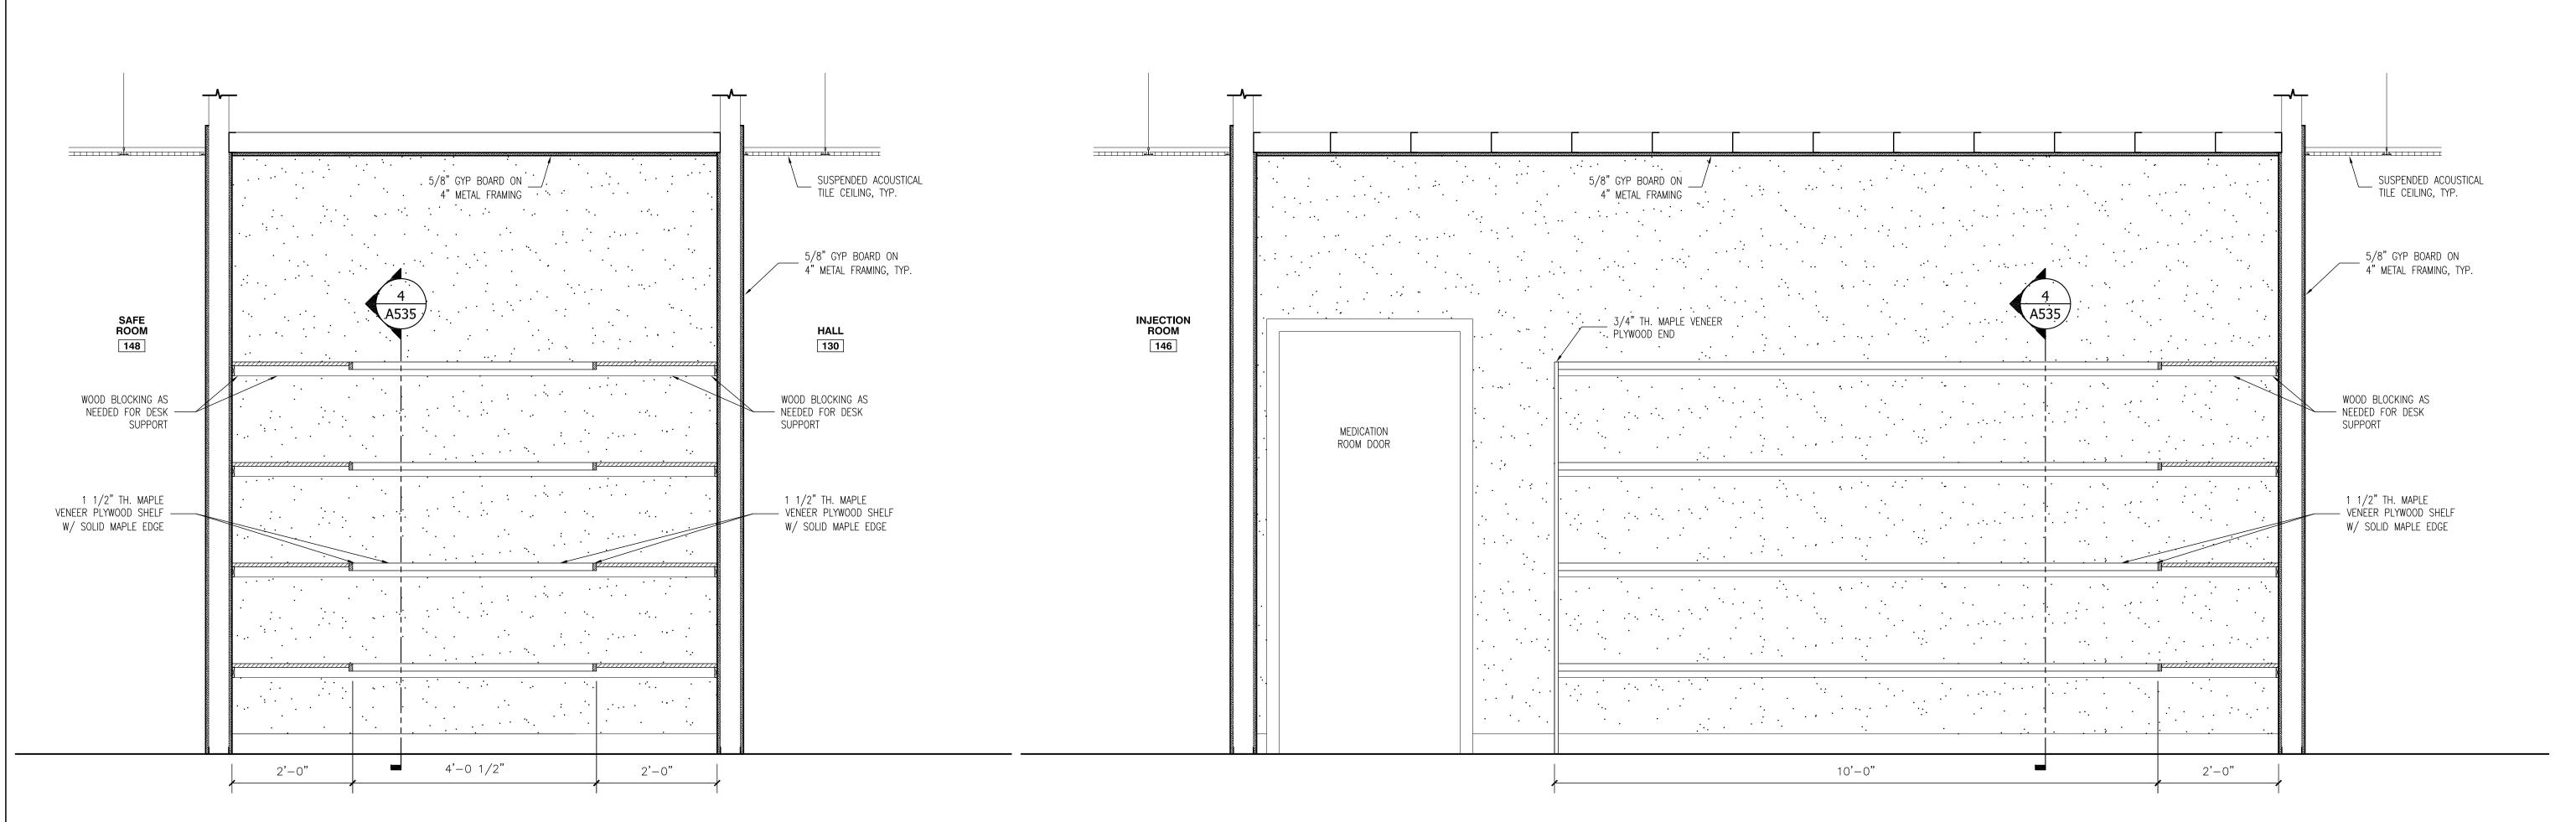




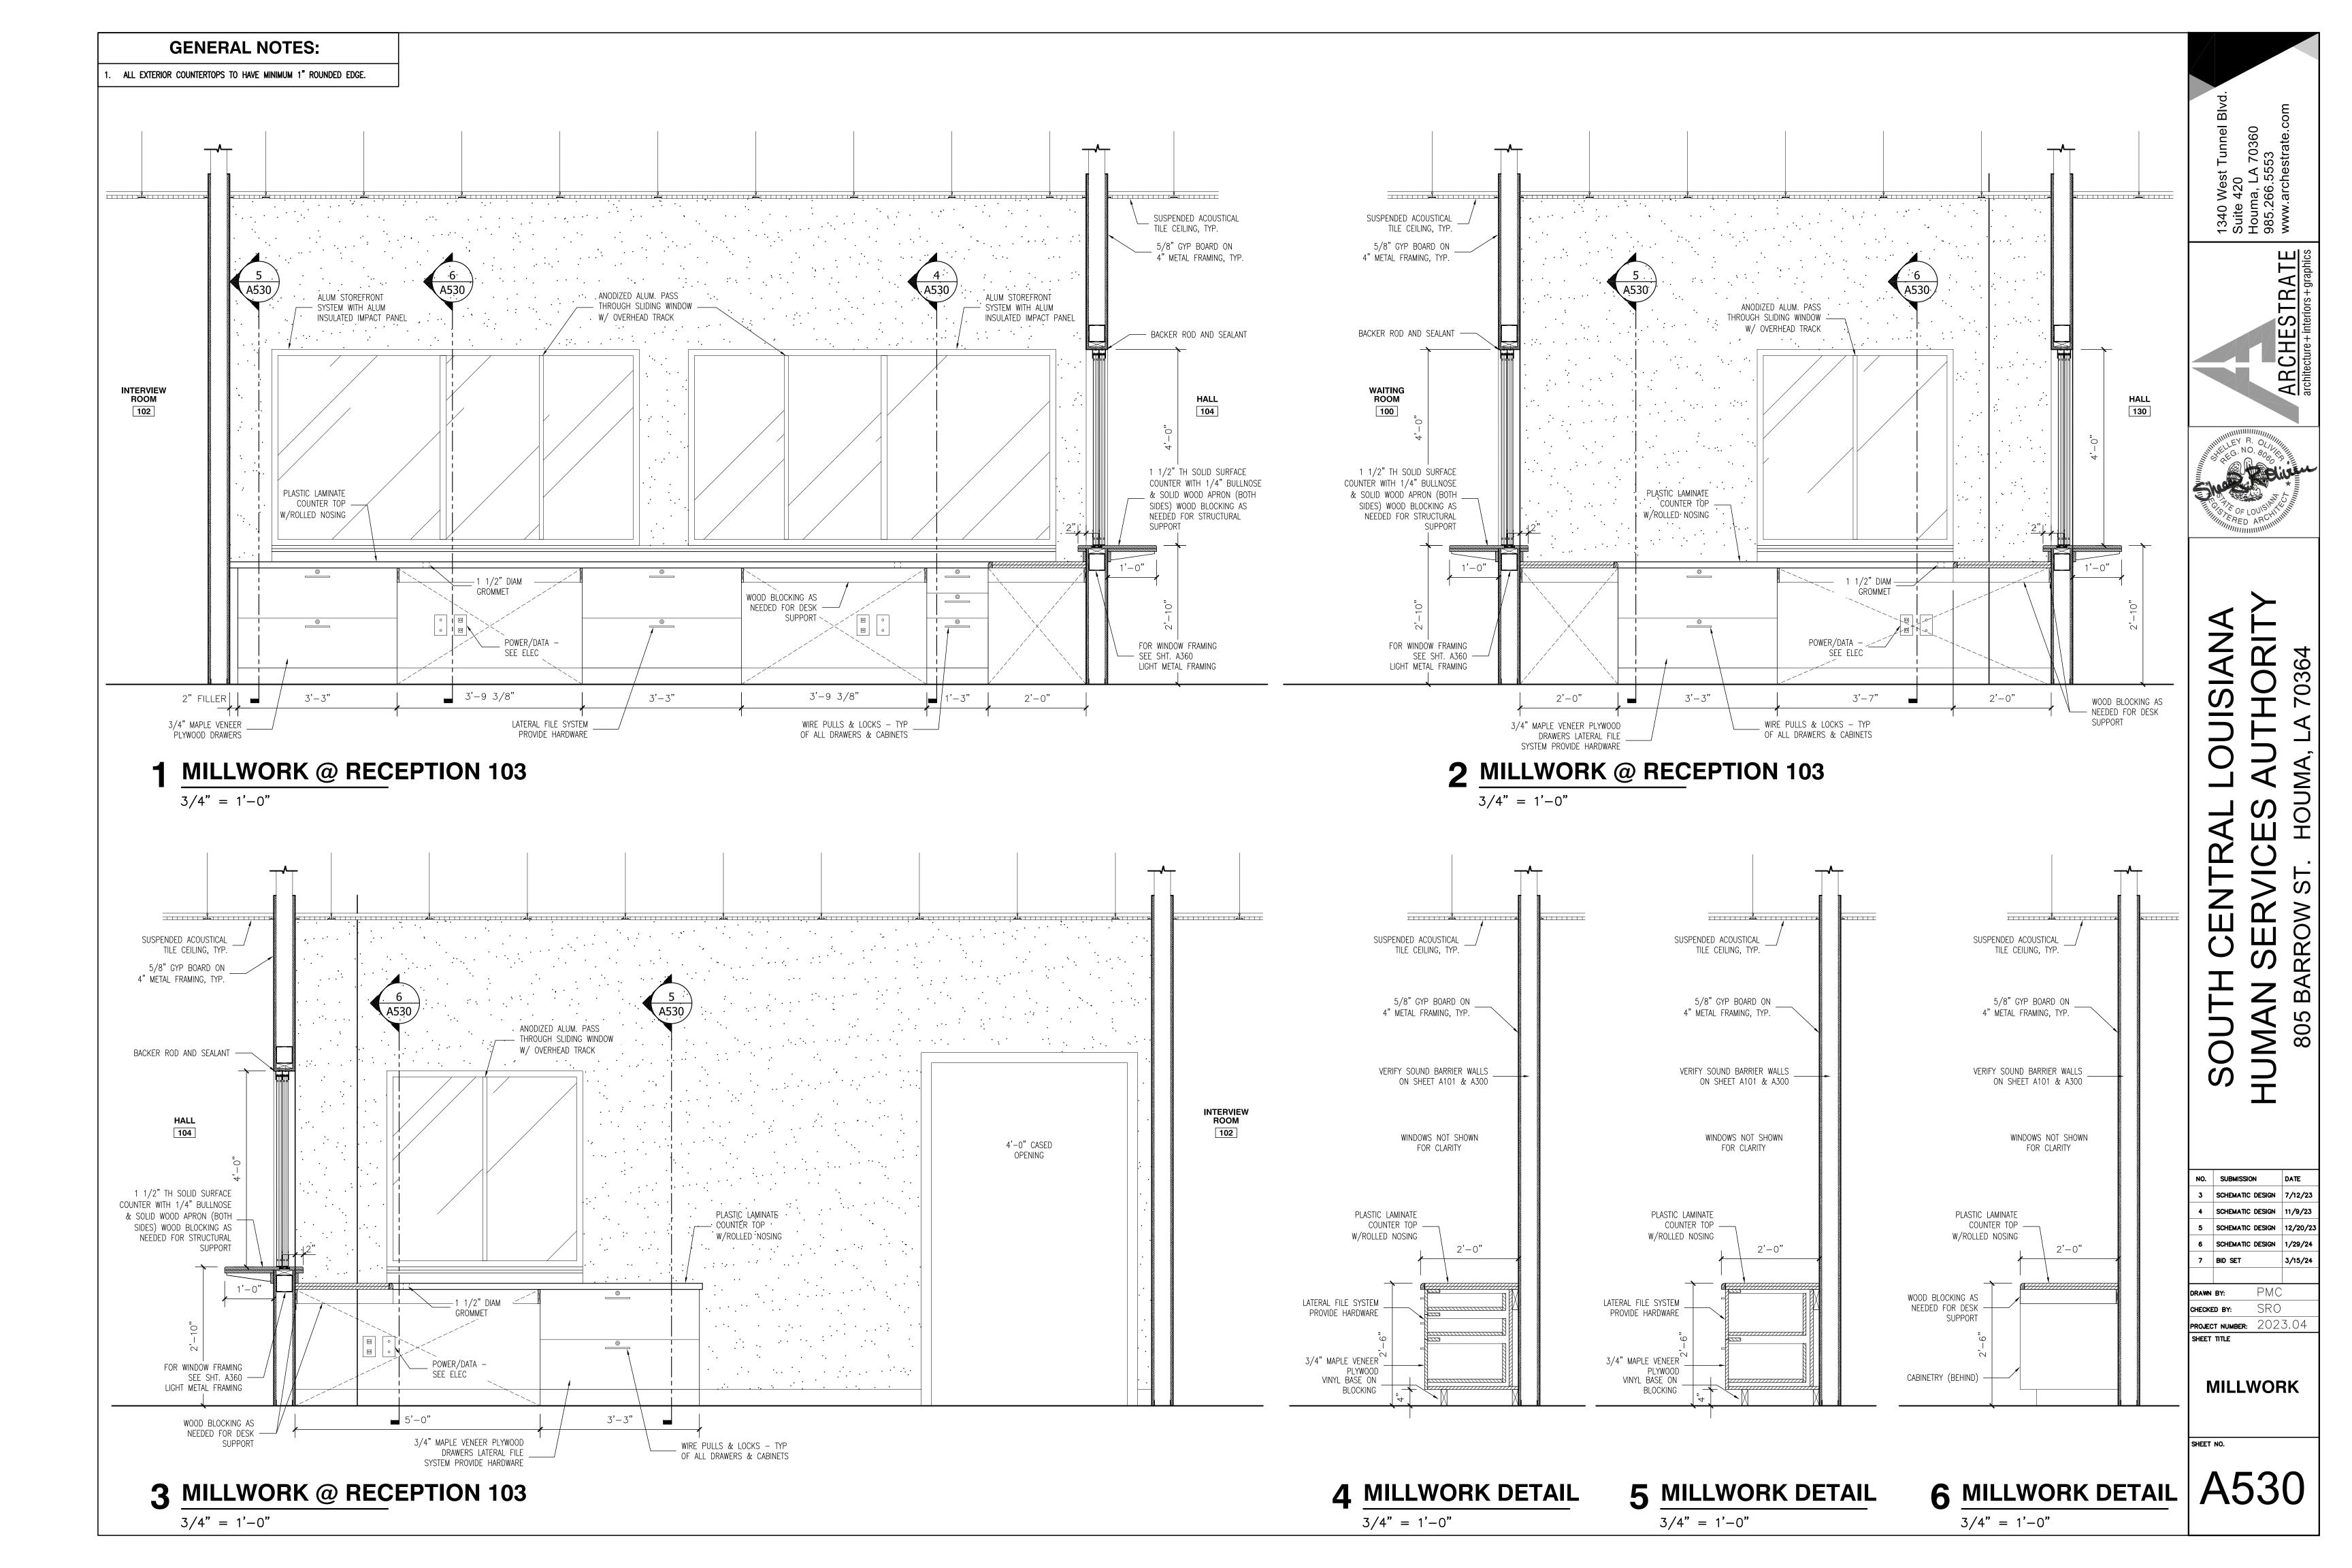

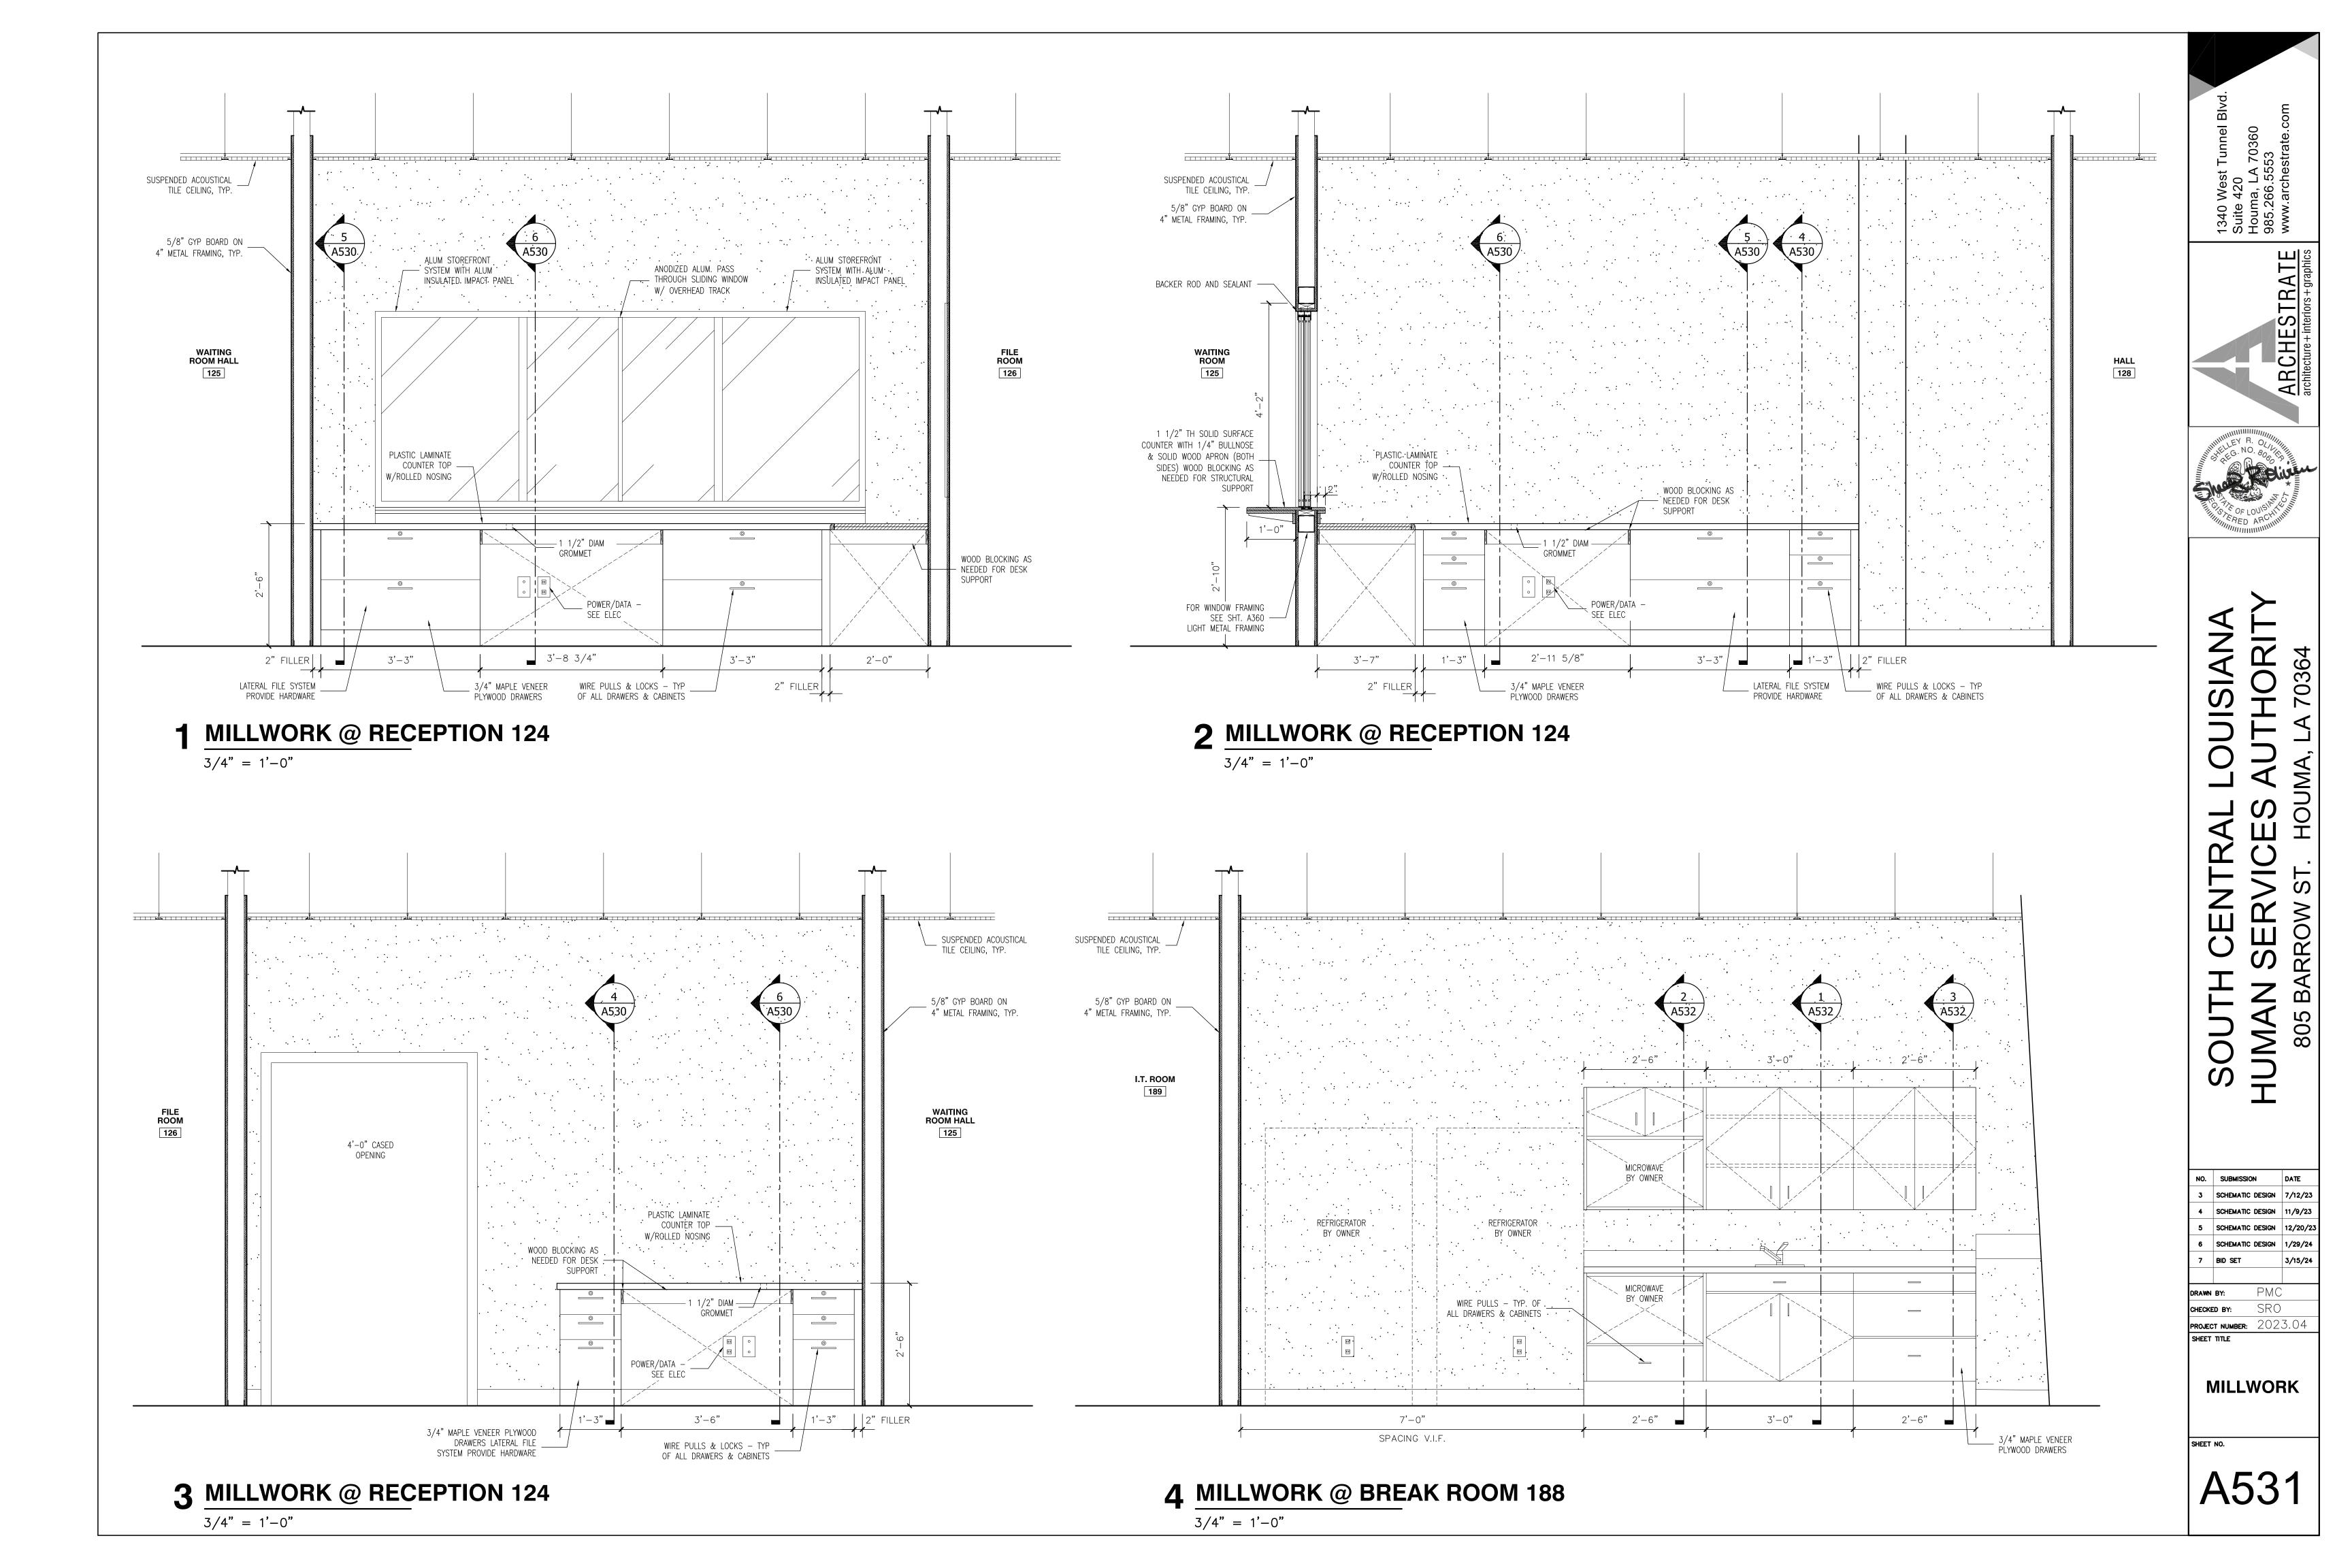


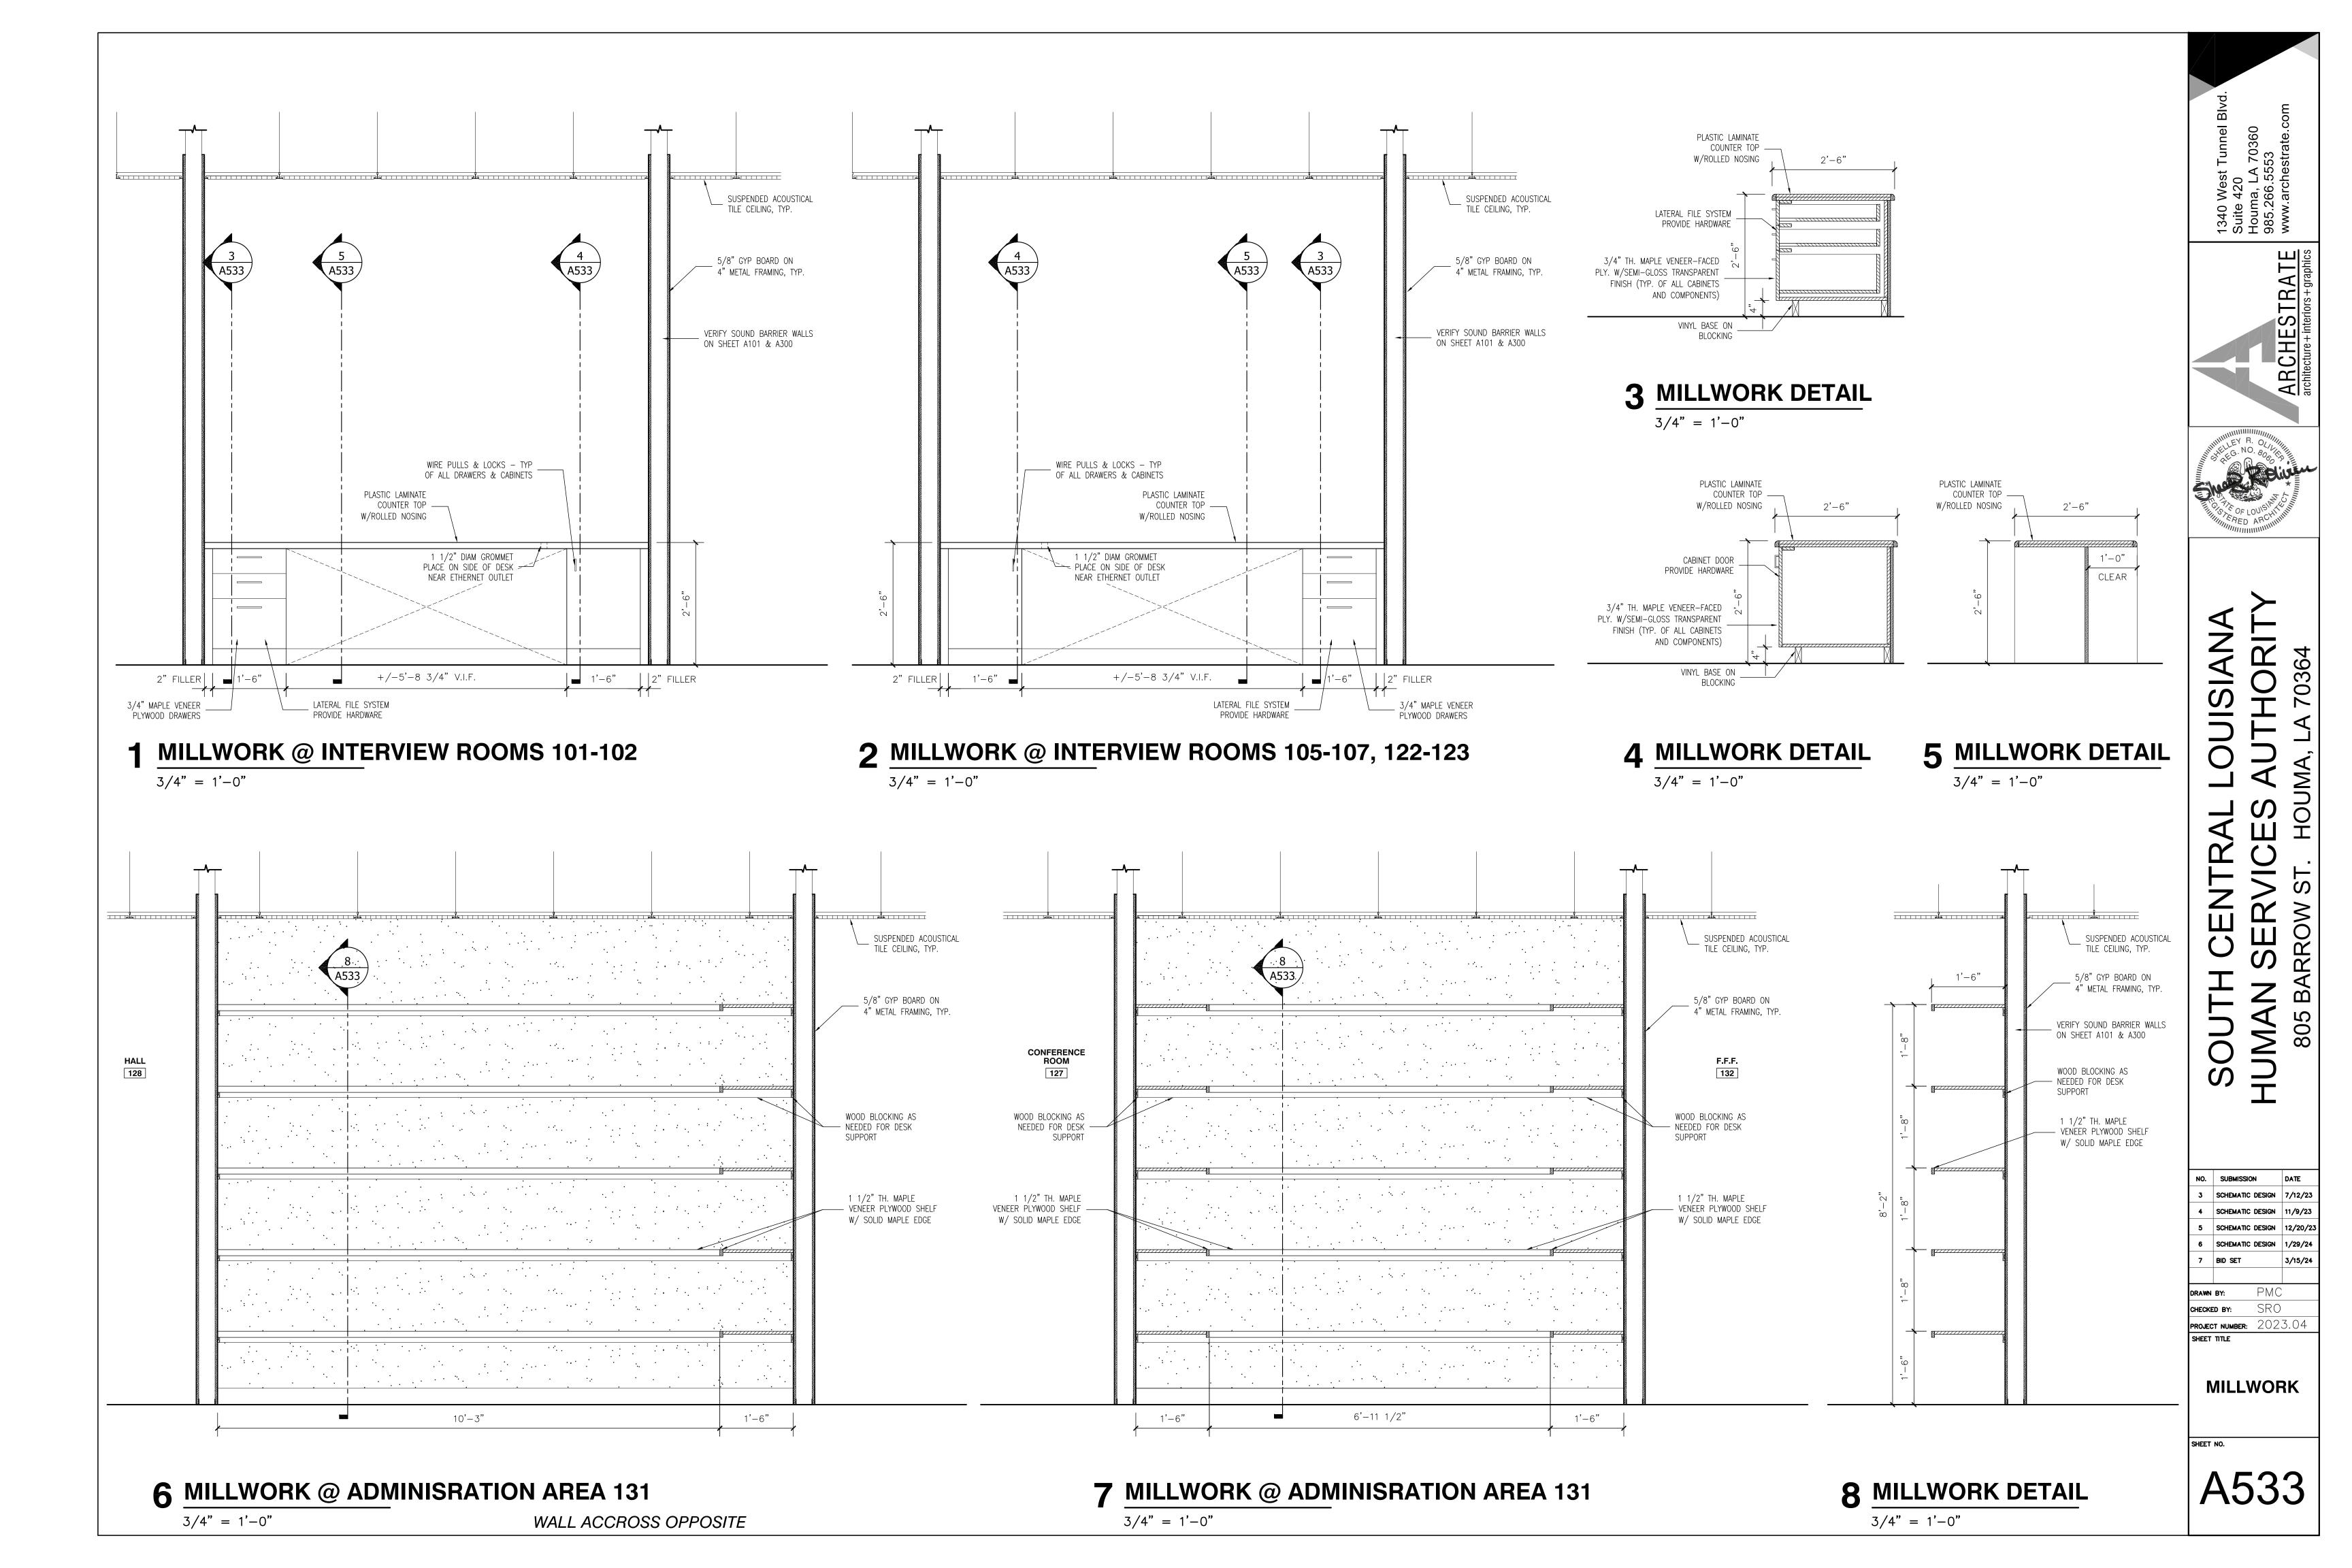

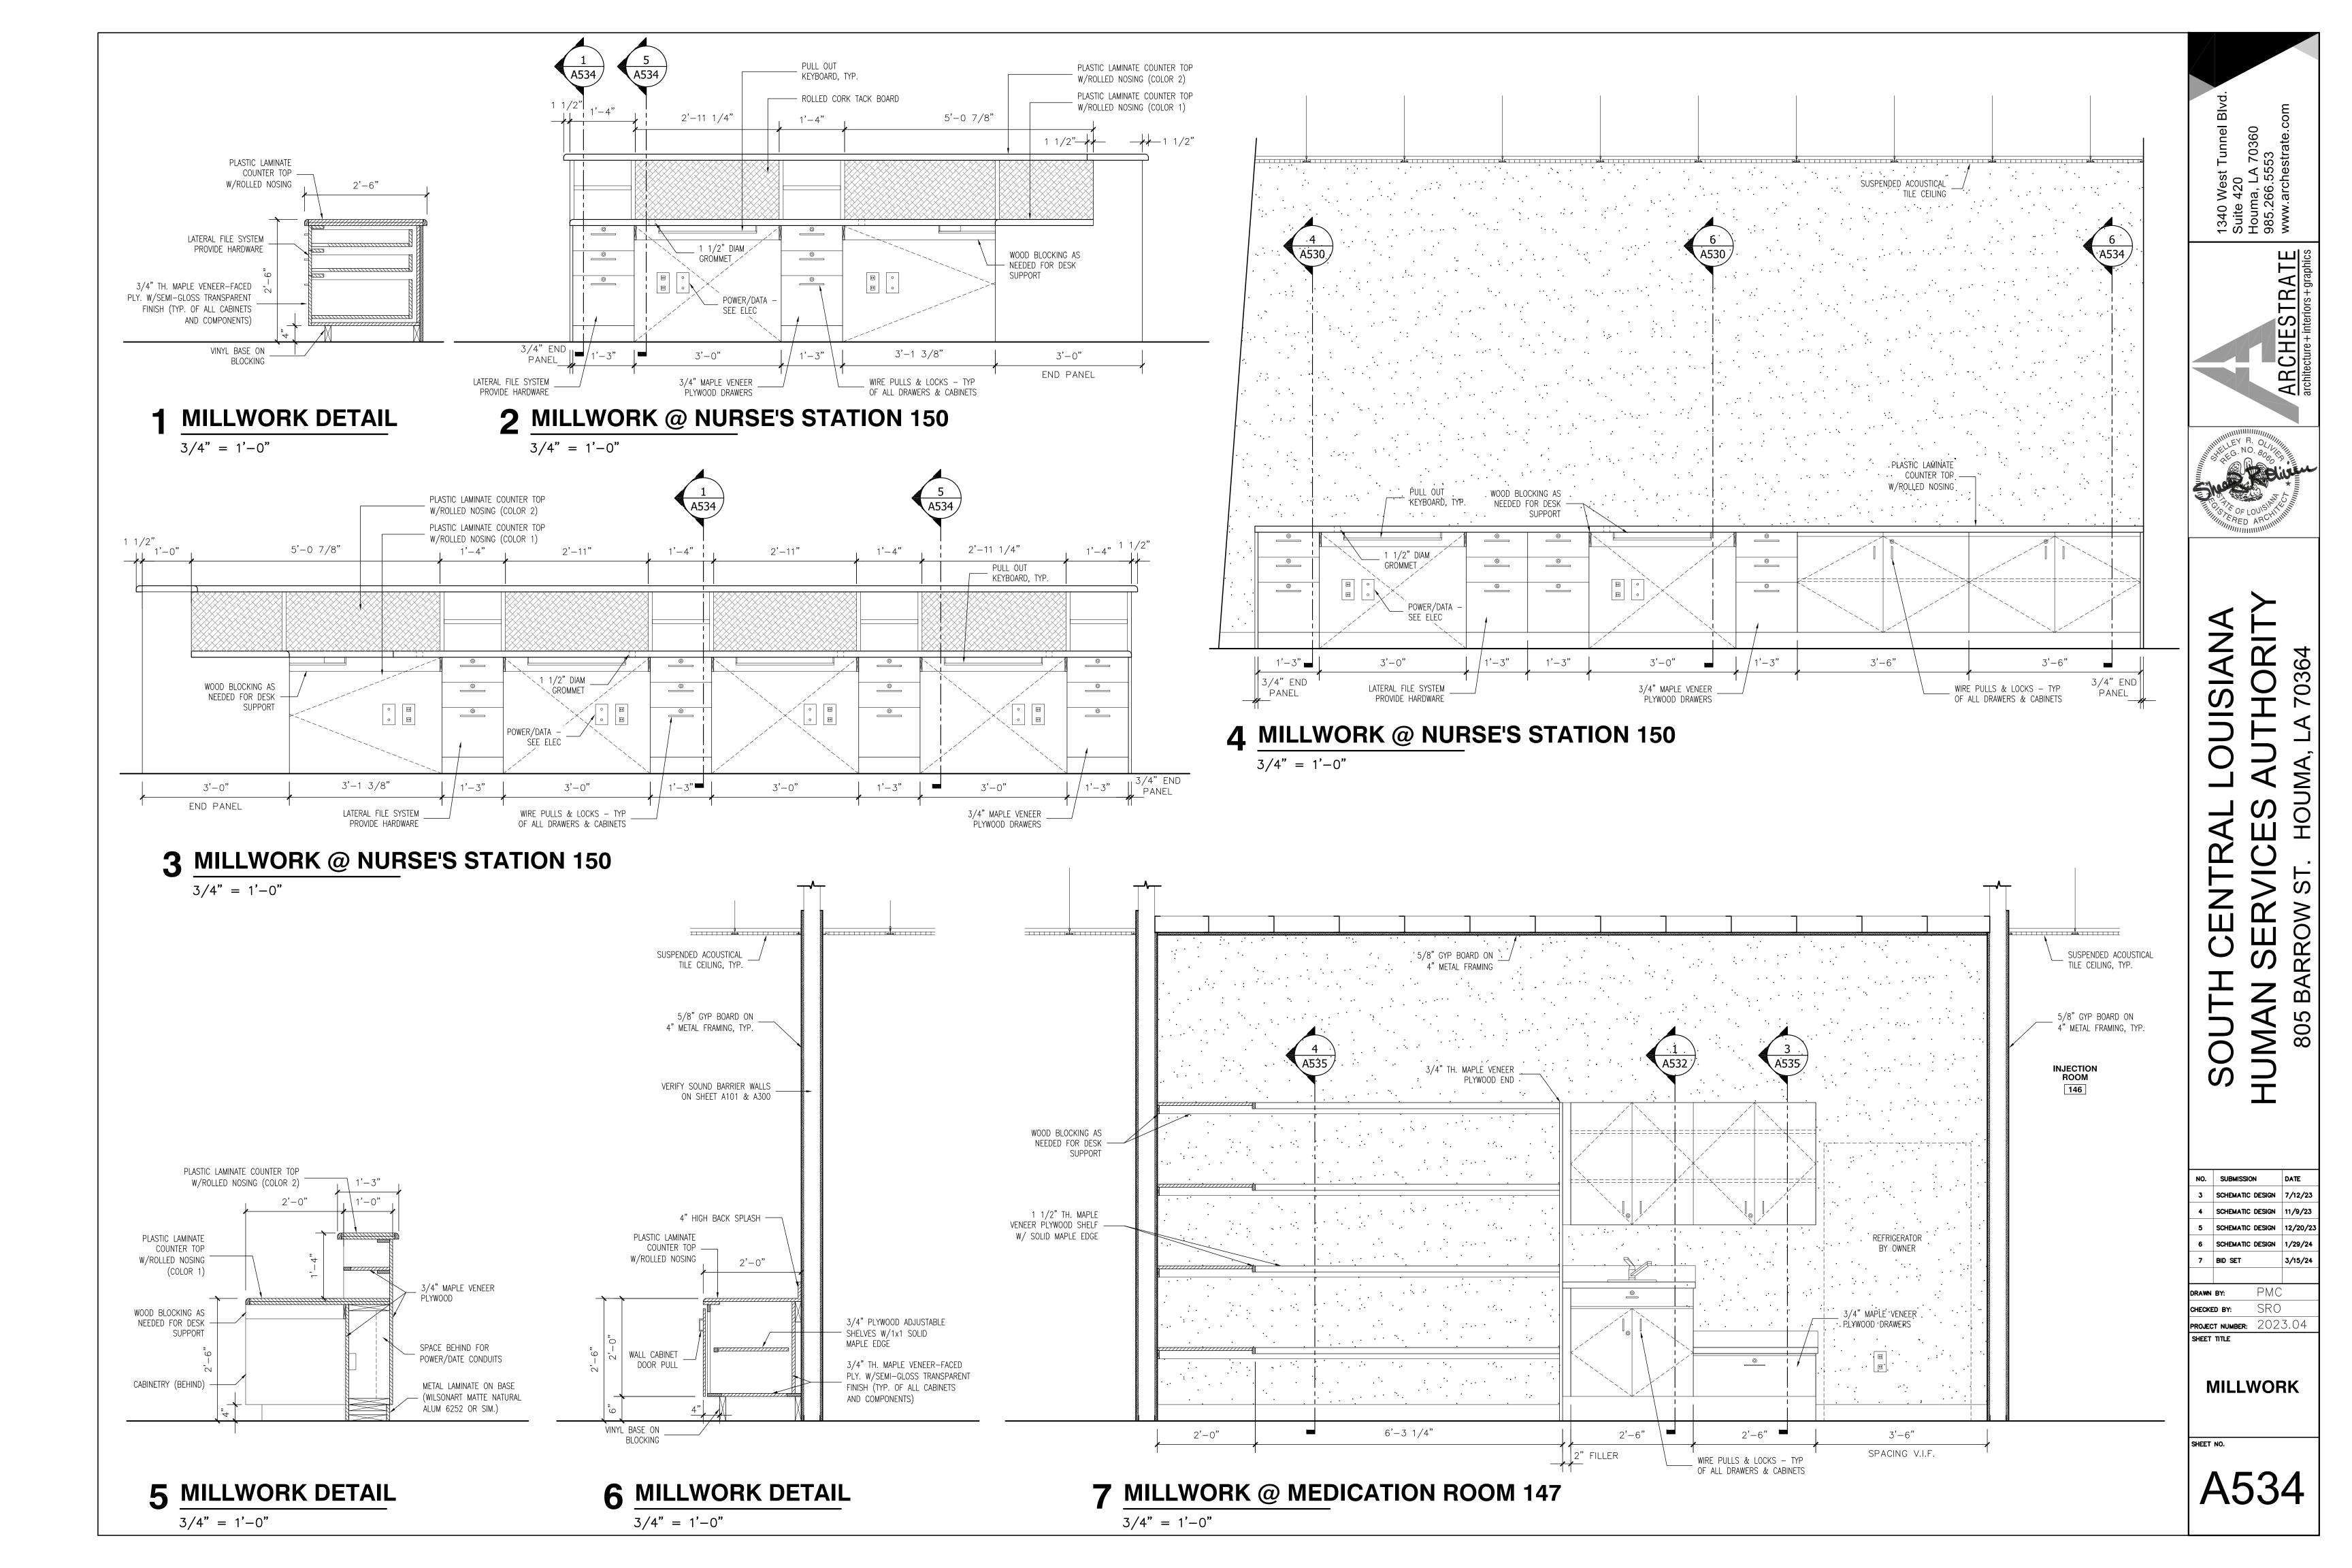

MILLWORK @ MEDICATION ROOM 147 3/4" = 1'-0"

2 MILLWORK @ MEDICATION ROOM 147 3/4" = 1'-0"

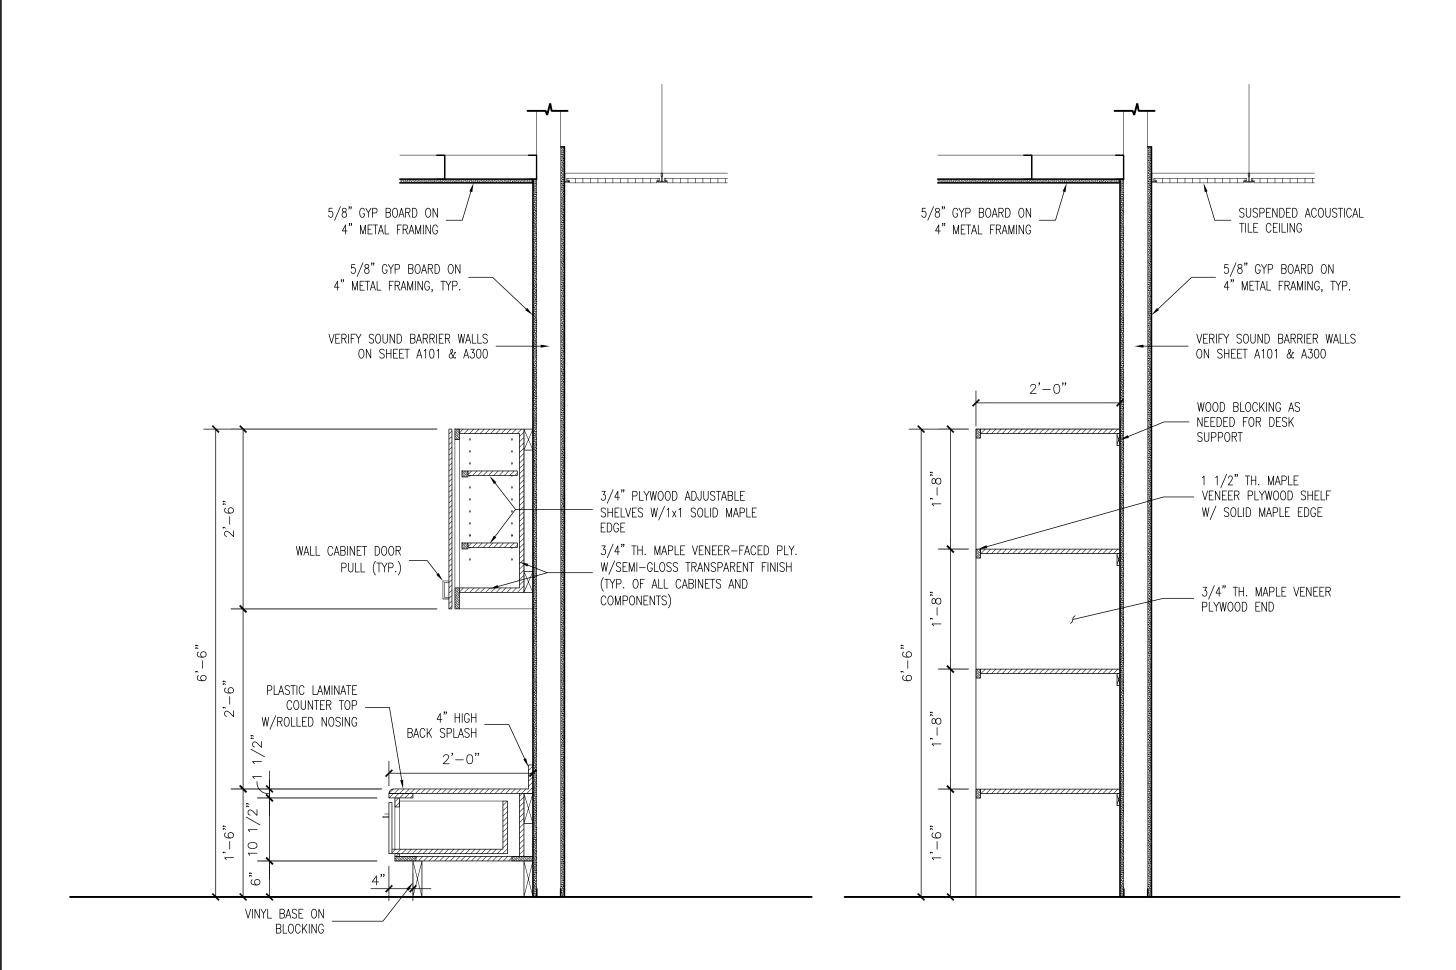

3 MILLWORK DETAIL 3/4" = 1'-0"

4 MILLWORK DETAIL

3/4" = 1'-0"

CEN SON

SCHEMATIC DESIGN 11/9/23 SCHEMATIC DESIGN 1/29/24

> PMC SRO

PROJECT NUMBER: 2023.04 SHEET TITLE

MILLWORK

					FINIS	H SCHEDULE								FINIS	H SCHEDULE				
ROOM	ROOM NAME	FLOOR BAS	E	W	/ALLS		CEILING	CEILING HEIGHT	REMARKS ROOM	ROOM NAME	FLOOR BASE		,	WALLS		CEILING	CEILING HEIGHT	REMARKS	
No.			NORTH	EAST	SOUTH	WEST GB	SAT-1		No.			NORTH	EAST	SOUTH	WEST GB	SAT-1			- lvd.
-	AITING ROOM TERVIEW ROOM	PSC BASE		GB GB	GB GB	GB	SAT-1	9'-11"	174	WAIVER OFFICE GROUP COUNS. RM.	+		GB	GB	GB	SAT-1	9'-11"		30 e.col
	TERVIEW ROOM	PSC BASE		GB	GB	GB	SAT-1	9'-11"	176	GROUP COUNS. RM.	+ + + + + + + + + + + + + + + + + + + +		GB	GB	GB	SAT-1	9'-11"		1340 West Tunn Suite 420 Houma, LA 7036 985.266.5553 www.archestrate
	ECEPTION	PSC BASE		GB	GB	GB	SAT-1	9'-11"		CLINIC MANAGER	PSC BASE-		GB	GB	GB	SAT-1	9'-11"		est 7 20 LA 3.555 ches
104	ALL TERVIEW ROOM	PSC BASE		GB GB	GB GB	GB GB	SAT-1	9'-11"		CLINIC SUPERVISOR COUNSELOR OFFICE	 		GB GB	GB GB	GB GB	SAT-1	9'-11"		0 W te 42 uma,266 w.ar
	TERVIEW ROOM	PSC BASE		GB	GB	GB	SAT-1	9'-11"		COUNSELOR OFFICE	-	+	GB	GB	GB	SAT-1	9'-11"		134 Sui Hou 985 www
	TERVIEW ROOM	PSC BASE		GB	GB	GB	SAT-1	9'-11"		COUNSELOR OFFICE	+	_	GB	GB	GB	SAT-1	9'-11"		1 %
—	ATHROOM	PSC BASE		PT-1	PT-1	PT-1	SAT-2	9'-11"		HALL	PSC BASE—		GB	GB	GB	SAT-1	9'-11"		ARCHESTRATE architecture + interiors + graphic
-	OMIN. SUPERVISOR ATHROOM	PSC BASE		GB PT-1	GB PT-1	GB PT-1	SAT-1	9'-11"	183	HALL	PSC BASE—1	+	GB GB	GB GB	GB GB	SAT-1	9'-11"		
	UPERVISOR OFFICE	+		GB	GB	GB	SAT-1	9'-11"	185	COUNSELOR OFFICE		<u> </u>	GB	GB	GB	SAT-1	9'-11"		-interi
112		PSC BASE		GB	GB	GB	SAT-1	9'-11"		COUNSELOR OFFICE	+ + + + + + + + + + + + + + + + + + + +		GB	GB	GB	SAT-1	9'-11"		H. H
113		CONC. BASE		MGB GB	MGB GB	MGB GB	SAT-2 SAT-1	9'-11"		HALL BREAK ROOM	PSC BASE—		GB GB	GB GB	GB GB	SAT-1	9'-11"		- Chitec
	FFICE SUPERVISOR	PSC BASE		GB	GB	GB GB	SAT-1	9'-11"		I.T. ROOM	CONC. BASE—	+	GB	GB	GB	SAT-1	9'-11"		
	TAFF OFFICE	PSC BASE		GB	GB	GB	SAT-1	9'-11"		PANTRY	PSC BASE-	1 GB	GB	GB	GB	SAT-1	9'-11"		anninining.
	TAFF OFFICE	PSC BASE		GB	GB	GB	SAT-1	9'-11"		PANEL ROOM	CONC. BASE-2		GB	GB	GB	_	OPEN		THE R. O. NO. 80 CHAIR
118	FFICE SUPERVISOR	PSC BASE		GB GB	GB GB	GB GB	SAT-1	9'-11"		EXISTING HALL EXISTING HALL	CONC. BASE - 2	-	GB	GB GB	GB GB		OPEN 7'-9"	REMOVE EXISTING WALL TILE & INSTALL 5/8" GYP. BOARD	
	ATHROOM	PSC BASE		PT-1	PT-1	PT-1	SAT-2	9'-11"		EXIST. LADIES ROOM	+ + + + + + + + + + + + + + + + + + + +		PT-1	PT-1	PT-1	_	7'-9"	CLEAN, PREP, & REPAINT GYP. BOARD CEILING	
121	ATHROOM	PSC BASE		PT-1	PT-1	PT-1	SAT-2	9'-11"		EXIST. MEN'S ROOM	1 2.102		PT-1	PT-1	PT-1	_	7'-9"	CLEAN, PREP, & REPAINT GYP. BOARD CEILING	THING E OF LOUIS HILITA
—	TERVIEW ROOM	PSC BASE		GB	GB	GB	SAT-1	9'-11"		HALL	PSC BASE—		GB	GB	GB	SAT-1	9'-11"		
	TERVIEW ROOM ECEPTION	PSC BASE		GB GB	GB GB	GB GB	SAT-1	9'-11"		STORAGE COUNSELOR OFFICE	PSC BASE—	_	GB GB	GB GB	GB GB	SAT-1	9'-11"		_
	AITING ROOM	PSC BASE		GB	GB	GB	SAT-1	9'-11"		COUNSELOR OFFICE			GB	GB	GB	SAT-1	9'-11"		⊣ >
	LE ROOM	PSC BASE		GB	GB	GB	SAT-1	9'-11"		COUNSELOR OFFICE	+ + + + + + + + + + + + + + + + + + + +	_	GB	GB	GB	SAT-1	9'-11"		□ ∢ Ĺ ∣
—	ONFERENCE ROOM	+		GB	GB	GB	SAT-1	9'-11"		COUNSELOR OFFICE	+ + + + + + + + + + + + + + + + + + + +		GB	GB	GB	SAT-1	9'-11"		
128		PSC BASE		GB GB	GB GB	GB GB	SAT-1 SAT-1	9'-11"		CONFERENCE ROOM CONFERENCE ROOM			GB GB	GB GB	GB GB	SAT-1	9'-11"		
130		PSC BASE		GB	GB	GB	SAT-1	9'-11"		EXISTING HALL	PSC BASE—	1 GB	GB	GB	GB	SAT-1	9'-11"		
131	DMINISTR. AREA	PSC BASE	-1 GB	GB	GB	GB	SAT-1	9'-11"	205	EXISTING JANITOR	CONC. BASE-	1 MGB	MGB	MGB	MGB	SAT-2	9'-11"		
132		PSC BASE		GB	GB	GB	SAT-1	9'-11"	206	EXISTING SPRIN. RM	I. CONC. –			_	_	_	OPEN	OLEAN OPOUT A DECEM FLOOD THE A DACE OLEAN DDED A	
133		PSC BASE		GB GB	GB GB	GB GB	SAT-1 SAT-1	9'-11"	207	EXIST. MEN'S ROOM	- -	_	-	_	_	SAT-2	9'-11"	CLEAN GROUT & RESEAL FLOOR TILE & BASE, CLEAN, PREP, & REPAINT GYP. BOARD WALLS	
135		PSC BASE		GB	GB	GB	SAT-1	9'-11"	208	EXIST. LADIES ROOM	л — — —	_	_	_	_	SAT-2	9'-11"	CLEAN GROUT & RESEAL FLOOR TILE & BASE, CLEAN, PREP, & REPAINT GYP. BOARD WALLS	
	TAFF OFFICE	PSC BASE		GB	GB	GB	SAT-1	9'-11"	209	EXISTING STORAGE	PSC BASE—	1 GB	GB	GB	GB	SAT-1	9'-11"	INCLIAINT OIL BOAND WALLS	
	TAFF OFFICE	PSC BASE		GB GB	GB GB	GB GB	SAT-1	9'-11"		CASE MANAGER			GB	GB	GB	SAT-1	9'-11"		□ ✨ ♨ ㅂ
	TAFF OFFICE	PSC BASE		GB	GB	GB	SAT-1	9'-11"		CASE MANAGER	PSC BASE—1		GB	GB	GB	SAT-1	9'-11"		
140	OPY ROOM	PSC BASE	-1 GB	GB	GB	GB	SAT-1	9'-11"		CASE MANAGER CASE MANAGER	PSC BASE—1	<u> </u>	GB GB	GB GB	GB GB	SAT-1 SAT-1	9'-11" 9'-11"		⊣ 卢 > [5]
		PSC BASE		PT-1	PT-1	PT-1	SAT 0	9'-11"		CASE MANAGER	PSC BASE-		GB	GB	GB	SAT-1	9'-11"		
	ATHROOM AITING ROOM	PSC BASE		PT-1	PT-1 GB	PT-1	SAT-2 SAT-1	9'-11"		CASE MANAGER	PSC BASE—		GB	GB	GB	SAT-1	9'-11"		SEI SEI
	URSE SUPERVISOR			GB	GB	GB	SAT-1	9'-11"		HALL CASE MANAGER	PSC BASE—1	<u> </u>	GB GB	GB GB	GB GB	SAT-1	9'-11"		
145	JECT. RM/VIT. SIG.	PSC BASE		GB	GB	GB	SAT-1	9'-11"		CASE MANAGER	PSC BASE—1	+	GB	GB	GB	SAT-1	9'-11"		⊢ ⊁ ァ ≴l
	JECTION ROOM	PSC BASE		GB	GB	GB	SAT-1	9'-11"	POON TO BE ENCLOSED DEP OWNER PROVIDED PHARMACY POOK	CASE MANAGER	PSC BASE-	-	GB	GB	GB	SAT-1	9'-11"		☐ ☐
	EDICATION ROOM AFE ROOM	PSC BASE		GB GB	GB GB	GB GB	GB SAT-1	9'-11"		HALL	PSC BASE—	+	GB	GB	GB	SAT-1	9'-11"		
	AFE RM./TELEHEA.	PSC BASE		GB	GB	GB	SAT-1	9'-11"		PREVENTION PREVENTION	PSC BASE—	+	GB GB	GB GB	GB GB	SAT-1	9'-11"		
	URSE'S STATION	PSC BASE		GB	GB	GB	SAT-1	9'-11"		EXISTING HALL	PSC BASE—		GB	GB	GB	SAT-1	9'-11"		\dashv \circ \dashv \mid
	PERSON DOCTOR PERSON DOCTOR	1		GB GB	GB GB	GB GB	SAT-1 SAT-1	9'-11"											_
	PERSON DOCTOR	+ + + + + + + + + + + + + + + + + + + +		GB	GB	GB	SAT-1	9'-11"											
154	NB	PSC BASE	-1 GB	GB	GB	GB	SAT-1	9'-11"											
155		PSC BASE		GB	GB	GB	SAT-1	9'-11"											NO. SUBMISSION DATE 3 SCHEMATIC DESIGN 7/12/23
—	AIVER OFFICE AIVER OFFICE	PSC BASE		GB GB	GB GB	GB GB	SAT-1	9'-11"											4 SCHEMATIC DESIGN 11/9/23
-	AIVER OFFICE AIVER OFFICE	PSC BASE		GB	GB	GB	SAT-1	9'-11"											5 SCHEMATIC DESIGN 12/20/23 6 SCHEMATIC DESIGN 1/29/24
159	ALL	PSC BASE	-1 GB	GB	GB	GB	SAT-1	9'-11"											7 BID SET 3/15/24
160		PSC BASE		GB	GB	GB	SAT-1	9'-11"								• • • • • • • • • • • • • • • • • • • •	FINISH SCH	HEDULE LEGEND	DRAWN BY: PMC
161	all Elehealth	PSC BASE		GB GB	GB GB	GB GB	SAT-1	9'-11"							ED AND STAINED		SLAR		CHECKED BY: SRO
	ELEHEALTH	PSC BASE		GB	GB	GB	SAT-1	9'-11"						CONC CLEAN PT PORCEI	AND SEAL EXIST				PROJECT NUMBER: 2023.04 SHEET TITLE
164	ELEHEALTH	PSC BASE	-1 GB	GB	GB	GB	SAT-1	9'-11"							O GYPSUM BOAR		,		
	DS TELEHEALTH	PSC BASE		GB CB	GB	GB	SAT-1	9'-11"						MGB MOISTU	RE RESISTANT PA	AINTED GYPSUM	BOARD		FINISH
166	all I PER. PEDIA. DR.	PSC BASE		GB GB	GB GB	GB GB	SAT-1	9'-11"						—	" PORCELAIN WA	LL TILE			SCHEDULE
168	OUNSELOR OFFICE	+		GB	GB	GB	SAT-1	9'-11"						BASE-1 4" VIN		/ WALL ADDAG	EVICTING MALL 15		
169		PSC BASE		GB	GB	GB	SAT-1	9'-11"						BASE-2 4" VIN' BASE-3 6"x12"			EXISTING WALL LE	TAVE AS IS	SHEET NO.
170	ALL AIVER OFFICE	PSC BASE		GB GB	GB GB	GB GB	SAT-1 SAT-1	9'-11"									RECT. 2'x2' TILES	- 15/16" GRID	A610
	AIVER OFFICE	PSC BASE		GB	GB	GB	SAT-1	9'-11"										CEILING TILE: RECT. 2'x2' TILES - 15/16" GRID	
—	N. OFFICE	PSC BASE		GB	GB	GB	SAT-1	9'-11"											

173 R.N. OFFICE

PSC BASE-1


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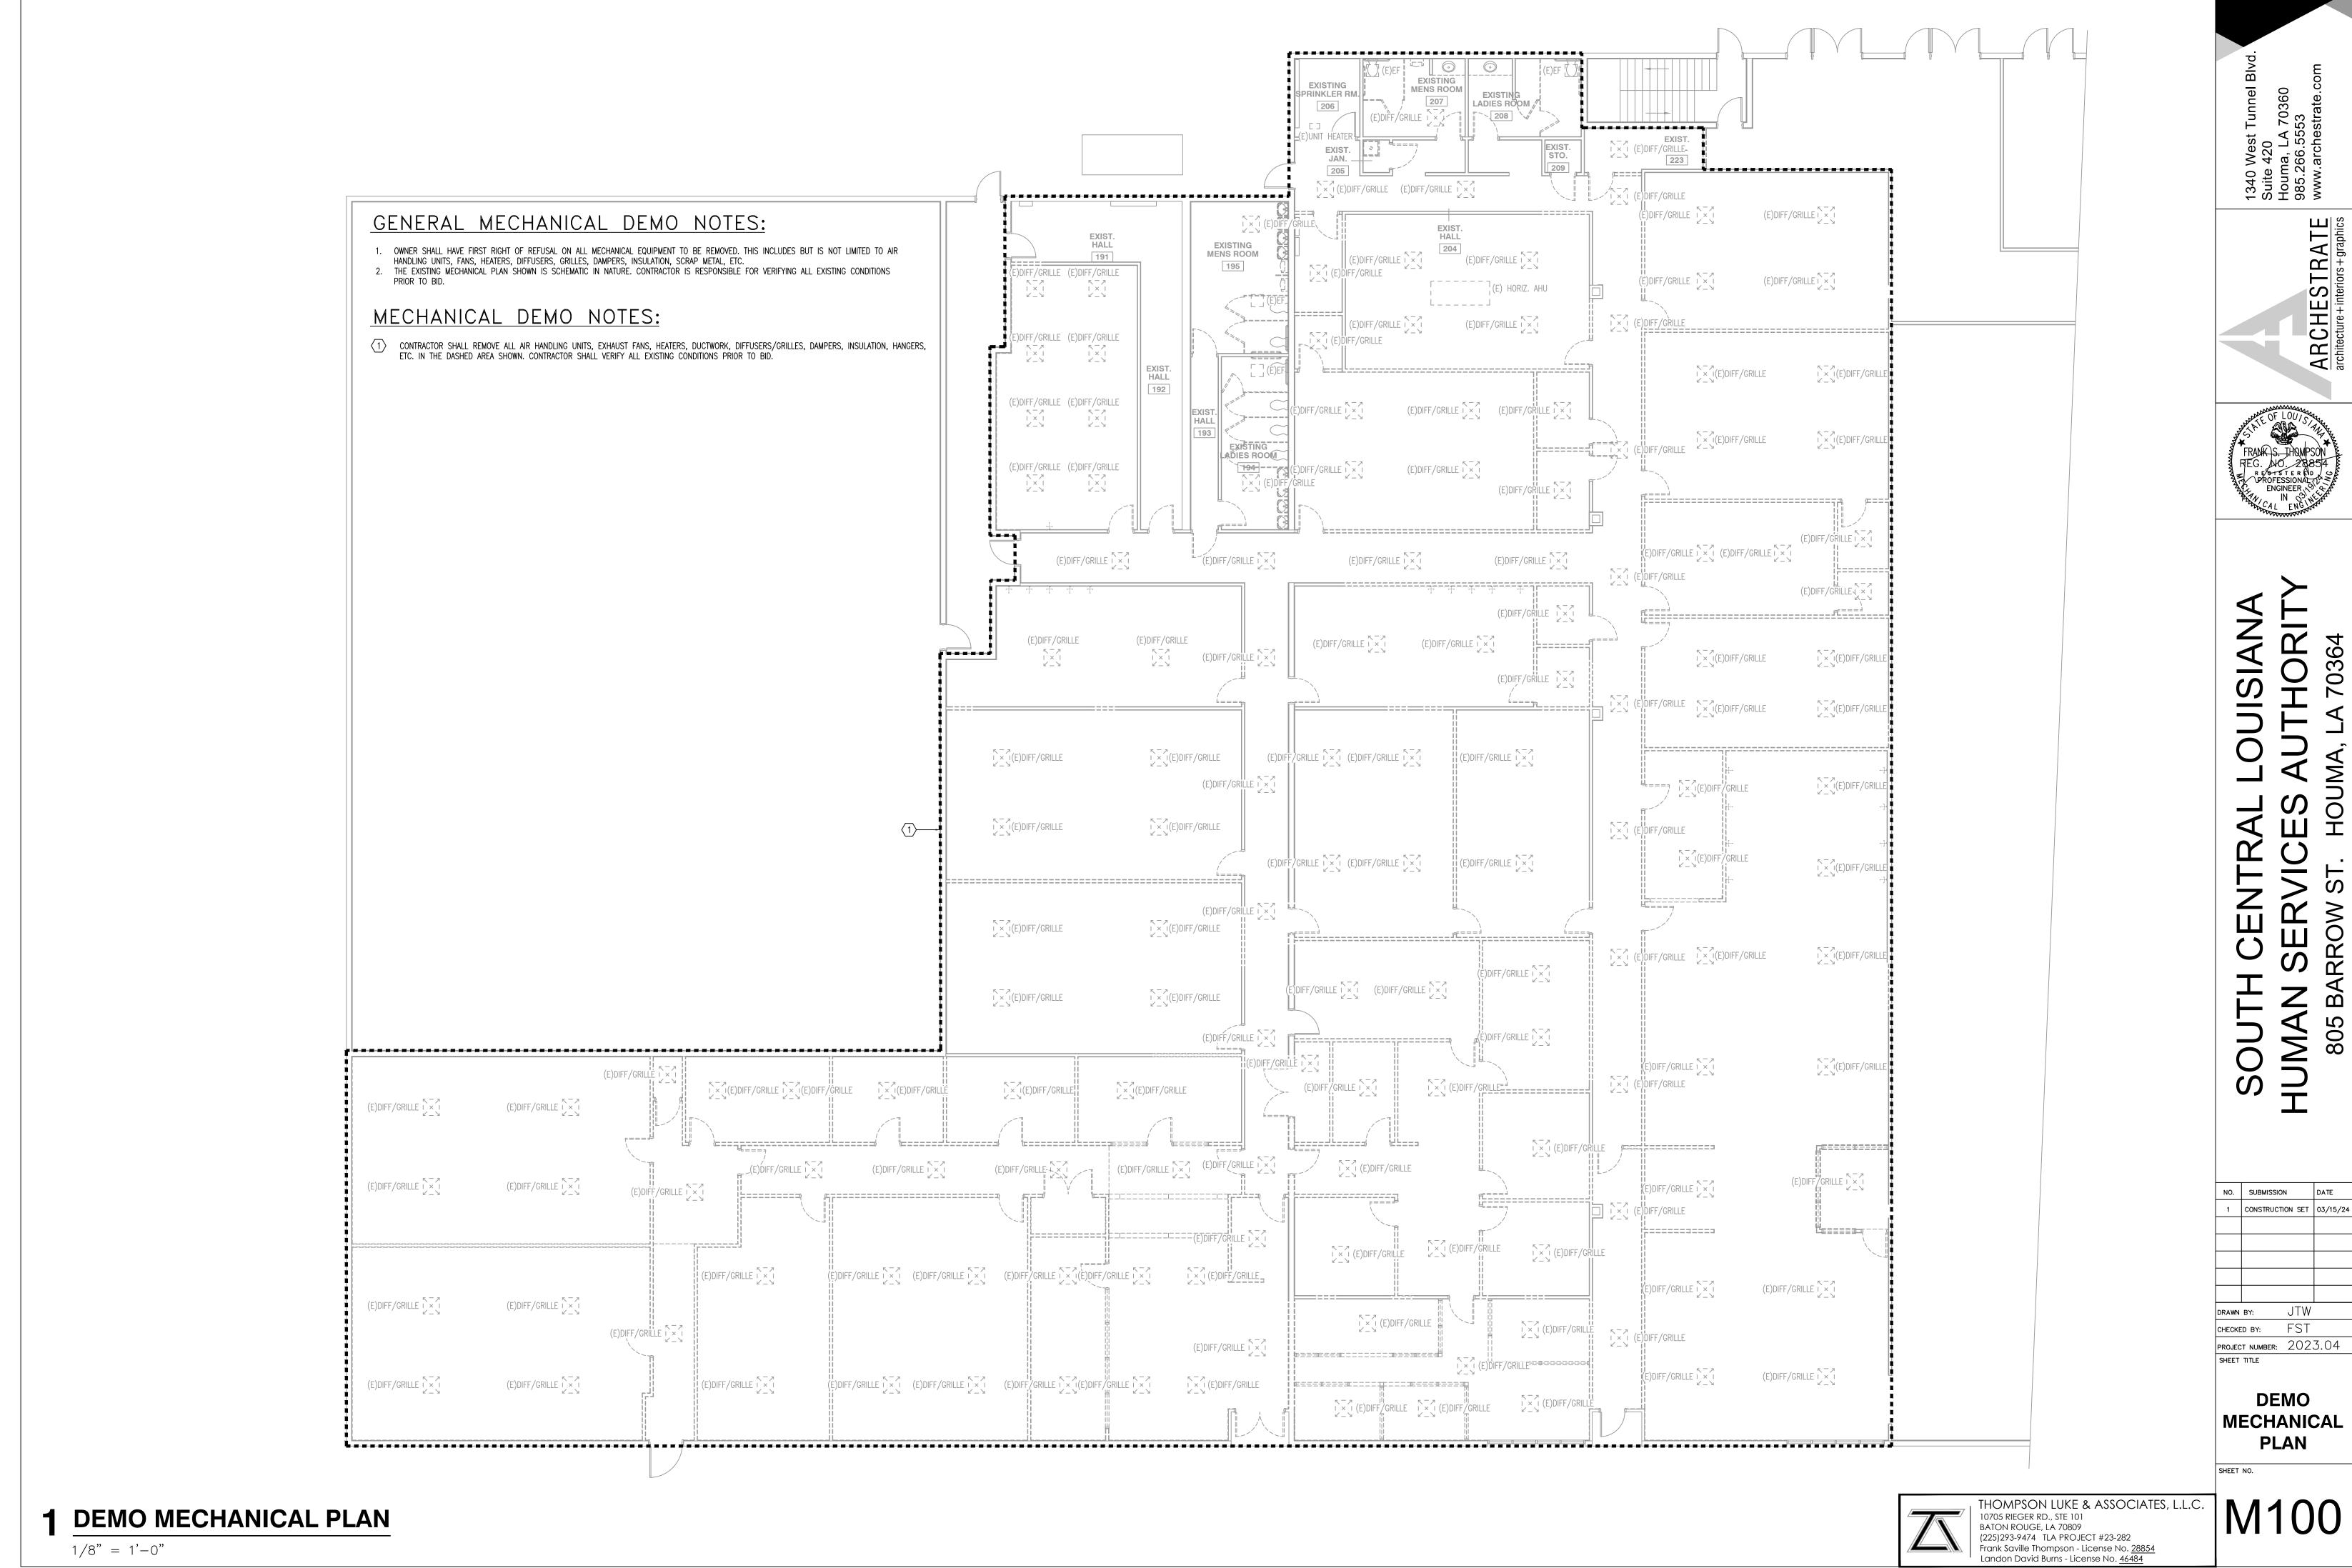
SAT-1


GB


GB

9'-11"



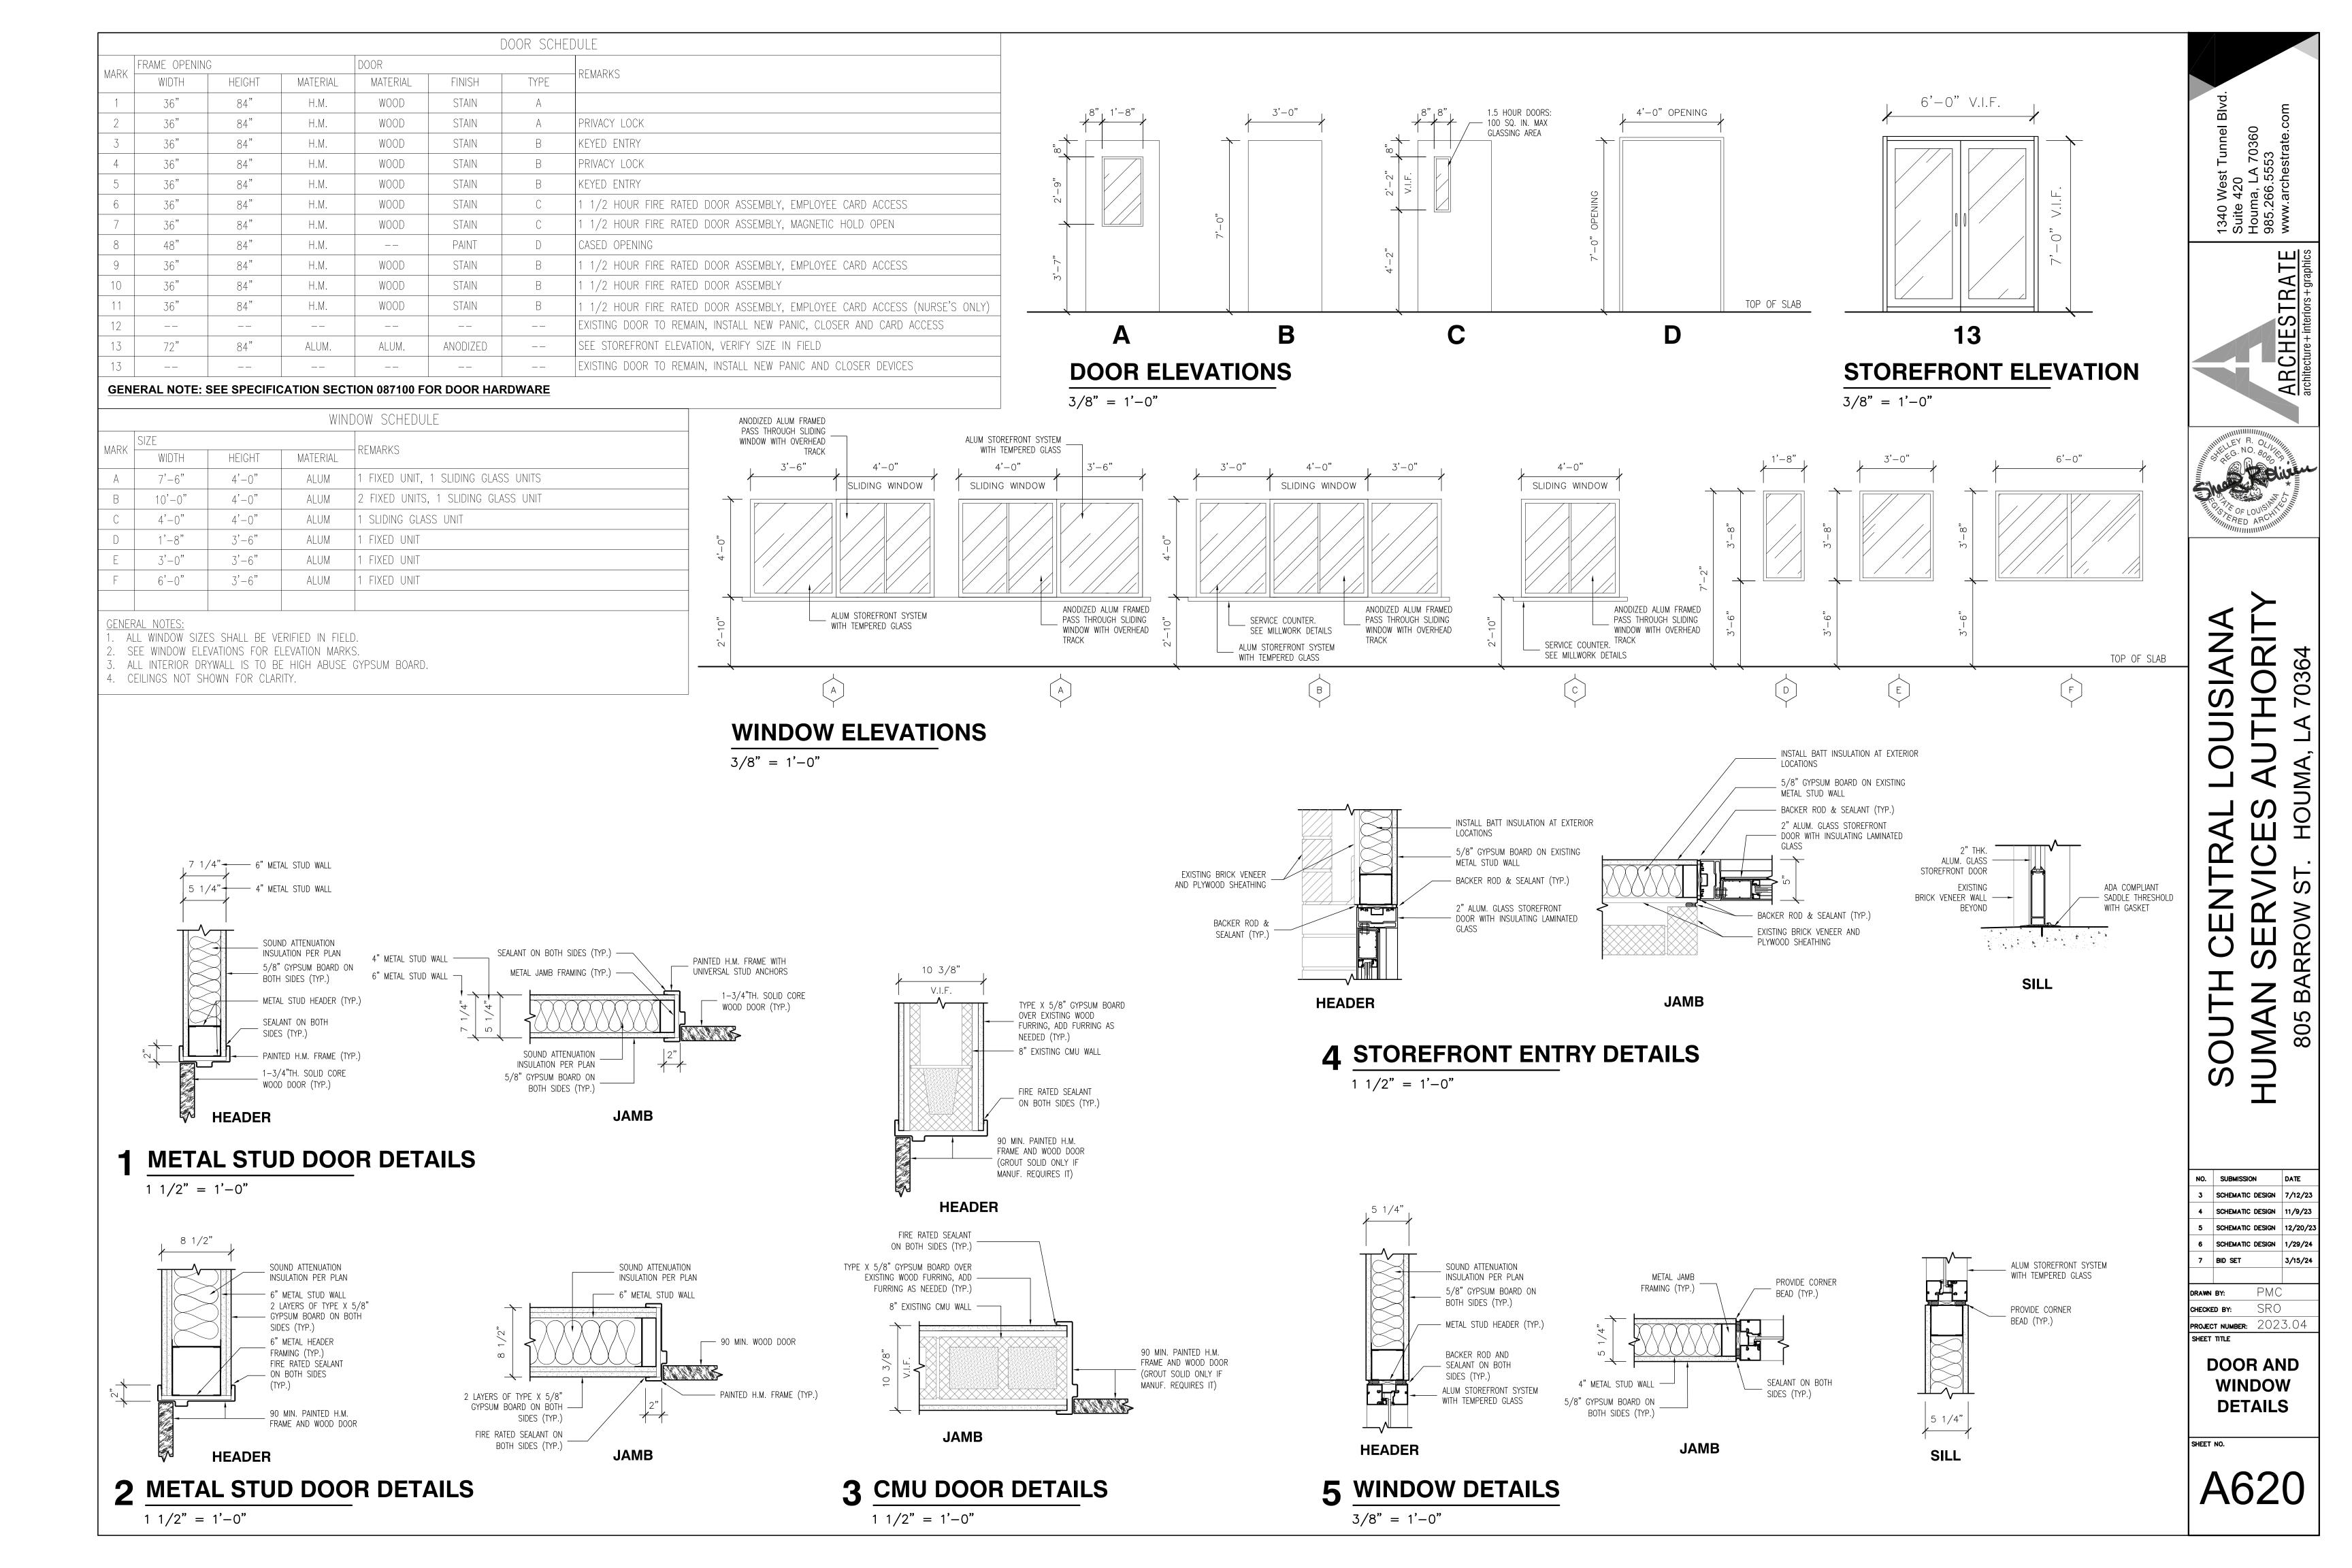

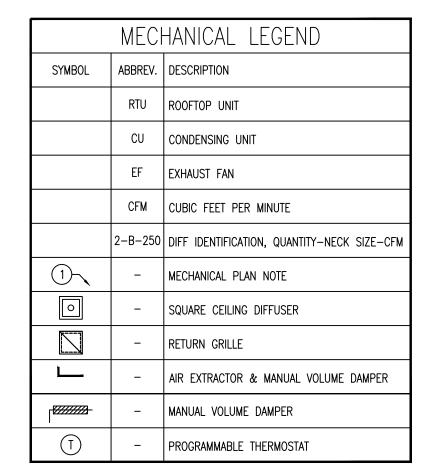

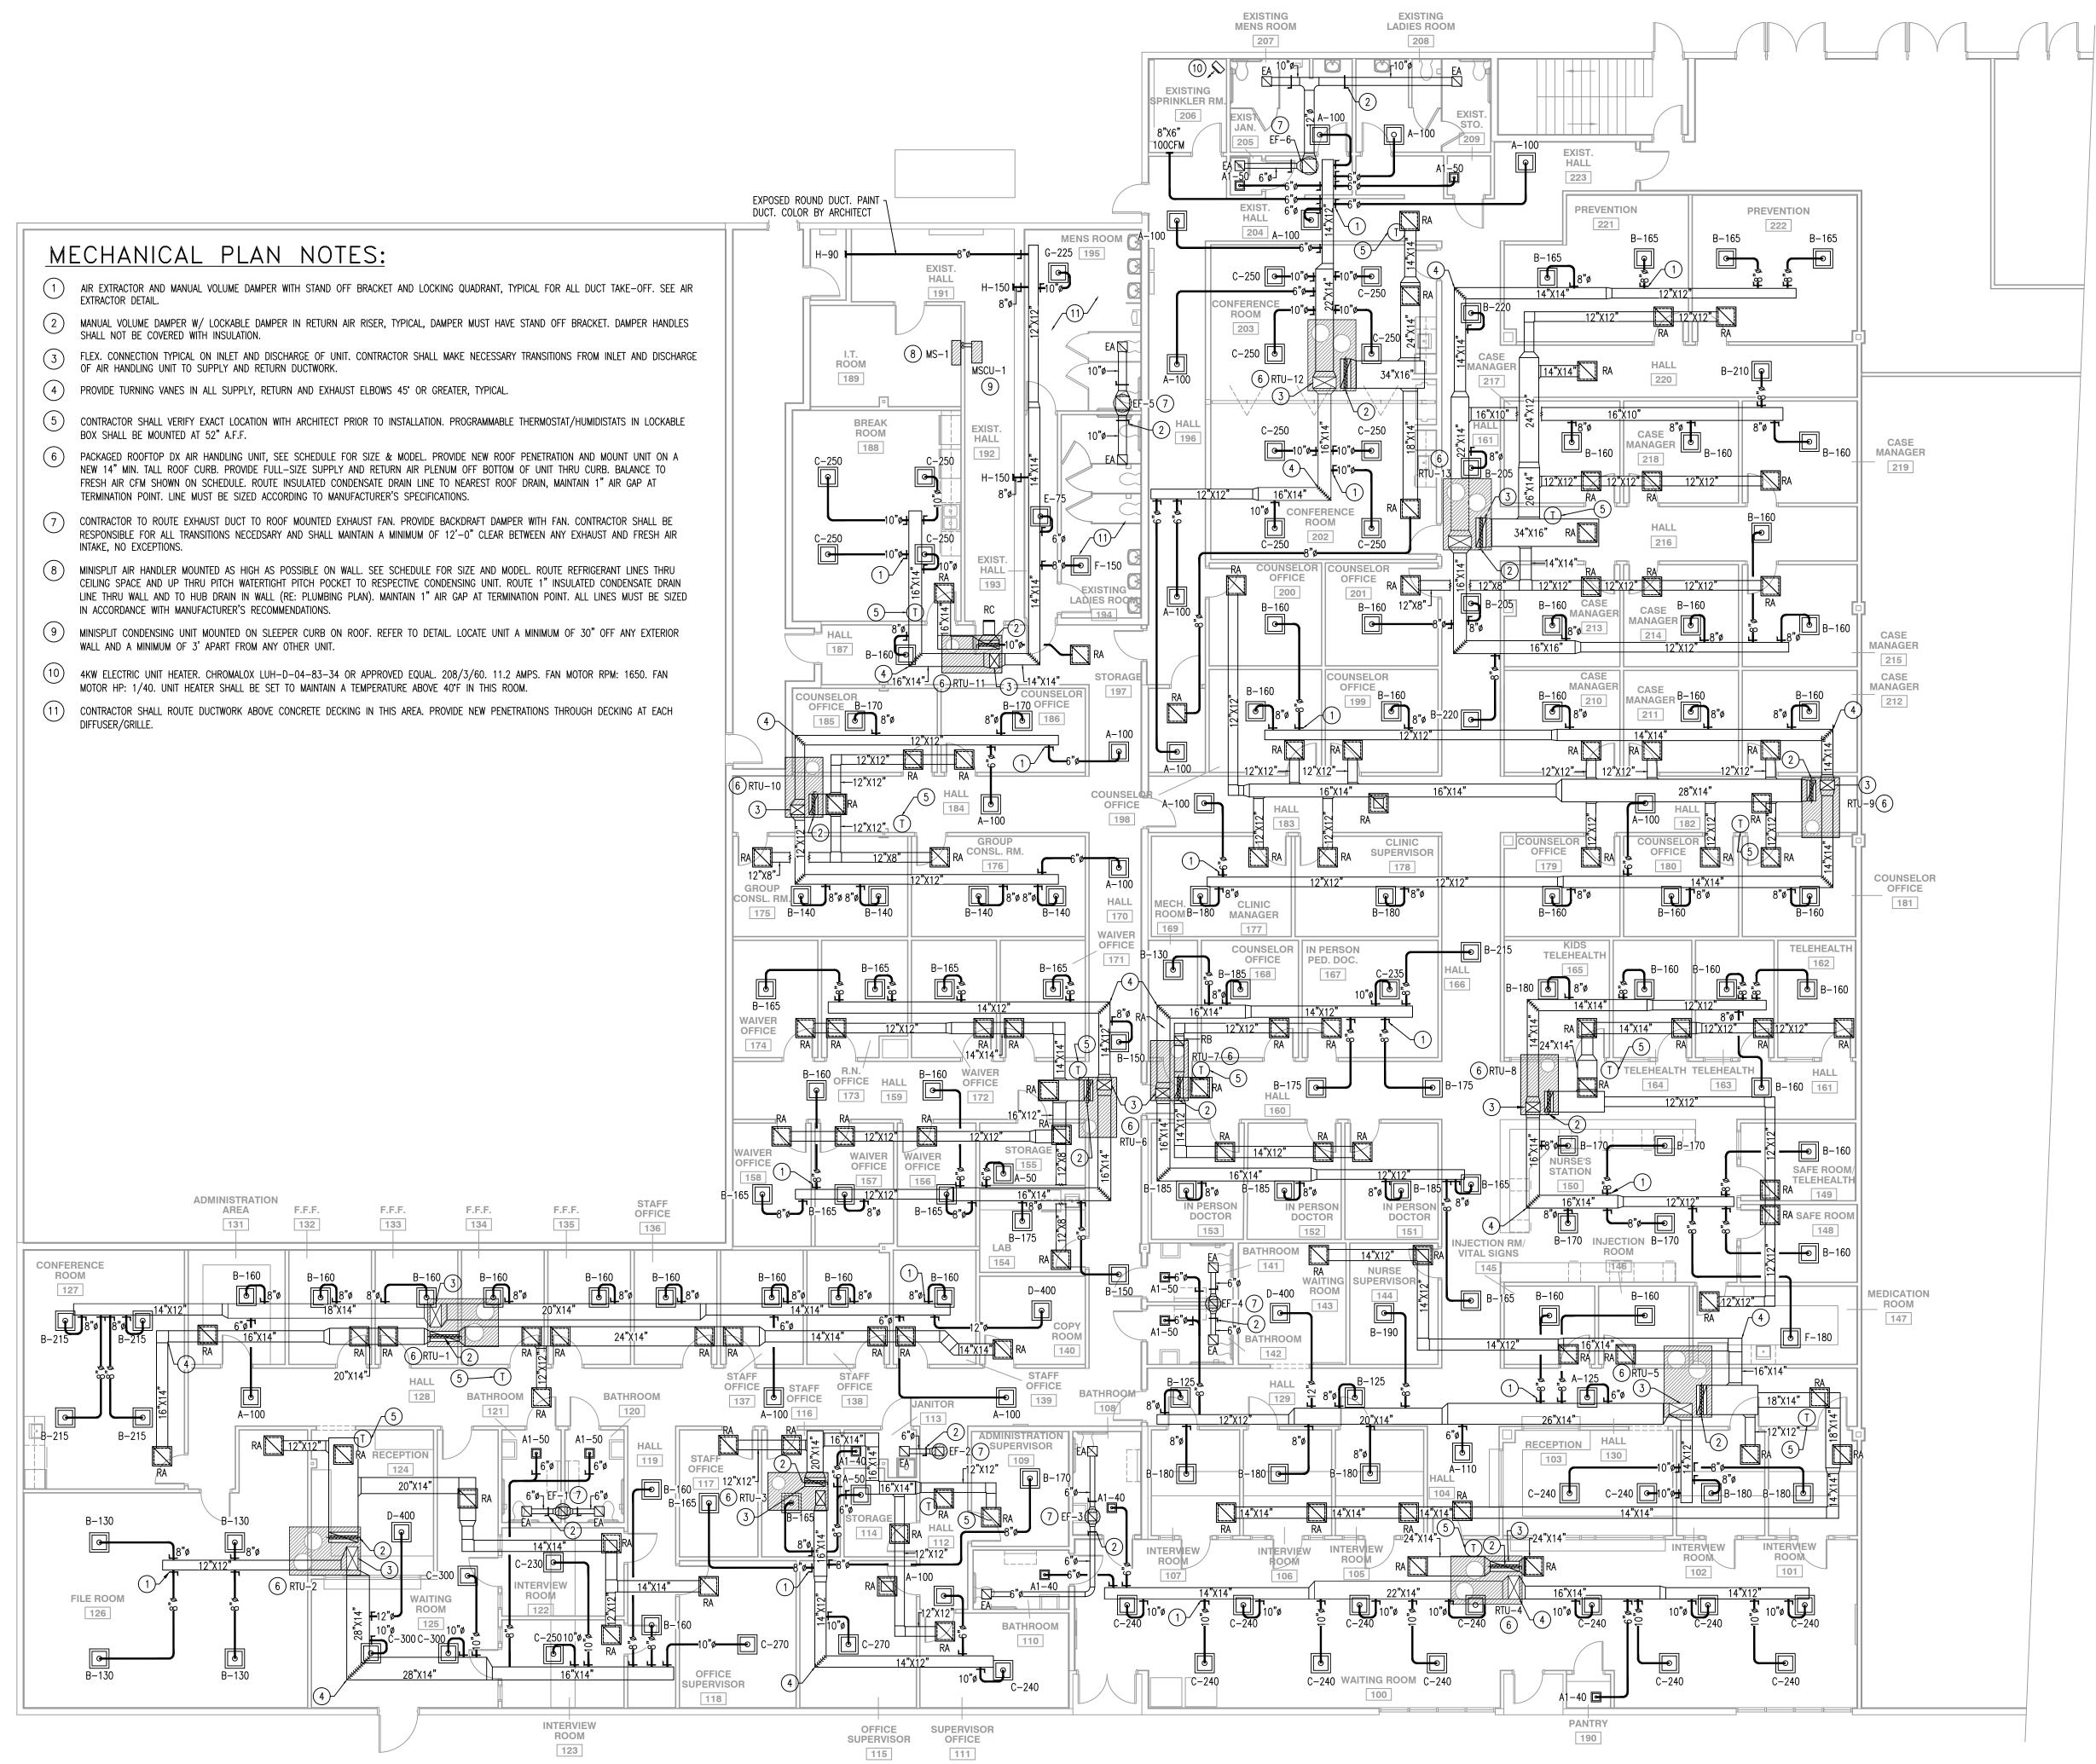

THOMPSON LUKE & ASSOCIATES, L.L.C. 10705 RIEGER RD., STE 101
BATON ROUGE, LA 70809
(225)293-9474 TLA PROJECT #23-282
Frank Savilla Nompson - License No. 28854 andon David Burns - License No. 46484

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NO. SUBMISSION DATE

CONSTRUCTION SET 03/15/24

JTW

FST

PROJECT NUMBER: 2023.04

MECHANICAL

PLAN

CHECKED BY:

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	GENERAL				SUPPLY	/ FAN			COMPRE	ESSORS	CON	D. FAN		EVAPO	RATION	COIL				ELECTRIC HE	EAT	ELECTRI	CAL (UNIT	<u> </u>	
MARK	SERVICE	TONS	TOTAL CFM	F.A. CFM	MIN EXT. S.P.	TOTAL S.P.	MAX RPM	FLA	NO. COMP.	RLA (EACH)	NO. FANS	FLA (EACH)	GROSS MBH	SENSIBLE MBH	ENT DB	. AIR WB	LV.	AIR WB	TOTAL K W	FLA	STAGES	ELECTRICAL SERVICE	MCA	MAX FUSE	MANUFACTURER
RTU-1	SEE PLAN	7.5	3000	300	0.5	1.00	2000	6.4	2	13.1	2	1.5	90.0	67.5	77.0°	63.0°	55.2°	53.4°	18.8	52.1	2	208/3φ/60	79	80	CARRIER 50FC OR APPROVED EQUAL
RTU-2	SEE PLAN	7.5	3000	300	0.5	1.00	2000	6.4	2	13.1	2	1.5	90.0	67.5	77.0°	63.0°	55.2°	53.4°	18.8	52.1	2	208/3φ/60	79	80	CARRIER 50FC OR APPROVED EQUAL
RTU-3	SEE PLAN	3.0	1200	120	0.5	1.00	1890	4.3	1	10.4	1	1.5	36.0	27.0	77.0°	63.0°	55.2°	53.4°	7.9	21.9	2	208/3φ/60	39	40	CARRIER 50FC OR APPROVED EQUAL
RTU-4	SEE PLAN	7.5	3000	300	0.5	1.00	2000	6.4	2	13.1	2	1.5	90.0	67.5	77.0°	63.0°	55.2°	53.4°	18.8	52.1	2	208/3φ/60	79	80	CARRIER 50FC OR APPROVED EQUAL
RTU-5	SEE PLAN	7.5	3000	300	0.5	1.00	2000	6.4	2	13.1	2	1.5	90.0	67.5	77.0°	63.0°	55.2°	53.4°	18.8	52.1	2	208/3φ/60	79	80	CARRIER 50FC OR APPROVED EQUAL
RTU-6	SEE PLAN	5.0	2000	200	0.5	1.00	2150	7.2	1	16.0	1	1.5	60.0	45.0	77.0°	63.0°	55.2°	53.4°	12.0	33.4	2	208/3φ/60	57	60	CARRIER 50FC OR APPROVED EQUAL
RTU-7	SEE PLAN	5.0	2000	200	0.5	1.00	2150	7.2	1	16.0	1	1.5	60.0	45.0	77.0°	63.0°	55.2°	53.4°	12.0	33.4	2	208/3φ/60	57	60	CARRIER 50FC OR APPROVED EQUAL
RTU-8	SEE PLAN	5.0	2000	200	0.5	1.00	2150	7.2	1	16.0	1	1.5	60.0	45.0	77.0°	63.0°	55.2°	53.4°	12.0	33.4	2	208/3φ/60	57	60	CARRIER 50FC OR APPROVED EQUAL
RTU-9	SEE PLAN	5.0	2000	200	0.5	1.00	2150	7.2	1	16.0	1	1.5	60.0	45.0	77.0°	63.0°	55.2°	53.4°	12.0	33.4	2	208/3φ/60	57	60	CARRIER 50FC OR APPROVED EQUAL
RTU-10	SEE PLAN	3.0	1200	120	0.5	1.00	1890	4.3	1	10.4	1	1.5	36.0	27.0	77.0°	63.0°	55.2°	53.4°	7.9	21.9	2	208/3φ/60	39	40	CARRIER 50FC OR APPROVED EQUAL
RTU-11	SEE PLAN	5.0	2000	200	0.5	1.00	2150	7.2	1	16.0	1	1.5	60.0	45.0	77.0°	63.0°	55.2°	53.4°	12.0	33.4	2	208/3φ/60	57	60	CARRIER 50FC OR APPROVED EQUAL
RTU-12	SEE PLAN	7.5	3000	300	0.5	1.00	2000	6.4	2	13.1	2	1.5	90.0	67.5	77.0°	63.0°	55.2°	53.4°	18.8	52.1	2	208/3φ/60	79	80	CARRIER 50FC OR APPROVED EQUAL
RTU-13	SEE PLAN	7.5	3000	300	0.5	1.00	2000	6.4	2	13.1	2	1.5	90.0	67.5	77.0°	63.0°	55.2°	53.4°	18.8	52.1	2	208/3φ/60	79	80	CARRIER 50FC OR APPROVED EQUAL

1. RTU SHALL BE SINGLE POINT ELECTRICAL SERVICE AS SCHEDULED UNDER A/C UNIT ELECTRICAL SERVICE AND A/C UNIT FLA.

2. RTU SHALL PROVIDE A MINIMUM OF 2 STAGES OF COOLING. 3. BE DUAL COMPRESSOR IF AVAILABLE AND A MINIMUM OF 13 SEER.

4. RTU SHALL HAVE A BELT DRIVE INDOOR SUPPLY FAN. 5. RTU SHALL BE FURNISHED AND INSTALLED WITH MANUFACTURER PROVIDED HOT GAS REHEAT COIL.

6. RTU SHALL HAVE HUMIDITY CONTROL.

7. RTU SHALL COME EQUIPPED WITH MOTORIZED & MANUAL FRESH AIR DAMPER AND HOOD.

8. RTU SHALL HAVE HAIL GUARD. 9. PROVIDE CONVENIENCE RECEPTACLE.

10. COORDINATE SMOKE DETECTOR INSTALLATION AND AUTOMATIC SHUT OFF REQUIREMENTS WITH FIRE ALARM CONTRACTOR.

11. PROVIDE UNIT WITH REMOTE OPERATOR DISPLAY, MOTORIZED DAMPER, AND HINGED ACCESS PANELS.

MINI SPL	IT AIR	HANDLING	UNIT	SCHEDULE	(MS)
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MARK	SERVICE	TYPE	MCA MFA	ELECTRIC SERVICE	INDOOR UNIT	OPTIONS
MS-1	SEE PLAN	WALL MOUNTED COOLING ONLY	12.2 15	208-1-60	DAIKEN FTK12NMVJU SERIES OR APPROVED EQUAL	REMOTE CONTROLLER

CONDENSATE SHALL BE GRAVITY FED TO NEAREST HUB DRAIN OR GRAVITY FED INDIRECTLY TO NEAREST PLUMBING VENT W/ P-TRAP.

CONTRACTOR SHALL VERIFY VOLTAGE REQUIREMENTS W/ ELECTRICAL PRIOR TO ORDERING.

3. CONTRACTOR SHALL COORDINATE W/ PLUMBING CONTRACTOR ANY NECESSARY PLUMBING REQUIREMENTS AND SHALL PROVIDE AND INSTALL AS NECESSARY TO PROVIDE COMPLETE AN OPERATIONAL SYSTEM.

CONDENSING UNIT SO	CHEDULE (MSCU) R-410A
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0011001		()							
PLAN MARK	SERVICE	TYPE	COOLING BTUH	MCA	MFA	FAN MOTOR FLA	COMPRESSOR RLA	ELECTRIC SERVICE	OUTDOOR UNIT
MSCU-1	SEE PLAN	COMPACT SIDE DISCHARGE	12000	12.2	15	0.15	7.5	208-1-60	DAIKEN RK12NMVJU SERIES OR APPROVED EQUAL
NOTES:	-						-	-	

NOTES: 1. UNIT SHALL BE PROVIDED W/ LOW AMBIENT KIT.

CONTRACTOR SHALL VERIFY VOLTAGE REQUIREMENTS W/ ELECTRICAL PRIOR TO ORDERING.

FAN SO	CHEDUI	_E						
PLAN MARK	TOTAL CFM	S.P. LOSS IN W.C.	115V INPUT WATTS OR HP	MAX. FAN RPM	DRIVE TYPE	MAXIMUM SONES/dBA	ELECTRIC SERVICE	REMARKS
EF-1	150	.25	1/60 HP	1257	DIRECT	2.5 SONES	120/1/60	GREENHECK G SERIES OR COOK APPROVED EQU

EF-1	150	.25	1/60 HP	1257	DIRECT	2.5 SONES	120/1/60	GREENHECK G SERIES OR COOK APPROVED EQUAL	1,2,3
EF-2	75	.25	1/60 HP	1381	DIRECT	2.8 SONES	120/1/60	GREENHECK G SERIES OR COOK APPROVED EQUAL	1,2,3
EF-3	150	.25	1/60 HP	1257	DIRECT	2.5 SONES	120/1/60	GREENHECK G SERIES OR COOK APPROVED EQUAL	1,2,3
EF-4	150	.25	1/60 HP	1257	DIRECT	2.5 SONES	120/1/60	GREENHECK G SERIES OR COOK APPROVED EQUAL	1,2,3
EF-5	525	.25	1/10 HP	1372	DIRECT	6.0 SONES	120/1/60	GREENHECK G SERIES OR COOK APPROVED EQUAL	1,2,3
EF-6	375	.25	1/30 HP	1050	DIRECT	4.5 SONES	120/1/60	GREENHECK G SERIES OR COOK APPROVED EQUAL	1,2,3

1. EXHAUST FANS SHALL BE TIED INTO RESPECTIVE LIGHT/OCCUPANCY SENSORS, TYPICAL. 2. EXHAUST FANS SHALL HAVE SPEED CONTROLLER ACCESSIBLE FROM FACE OF EXHAUST FAN.

3. ALL MOTORS MUST BE ECM TYPE.

DI	FFUSI	ER/GRILLE SC	HED	ULE		
SYM.	CFM RANGE	FACE SIZE	NECK SIZE	MATERIAL	FINISH/ COLOR	REMARKS
A1	0-120	12"X12"	6"ø	ALUMINUM	WHITE	PRICE ASCDA, TITUS TMSA-AA, LAY-IN SQUARE CEILING DIFF
Α	0-120	24"X24"	6"ø	ALUMINUM	WHITE	PRICE ASCDA, TITUS TMSA-AA, LAY-IN SQUARE CEILING DIFF
В	120-230	24"X24"	8"ø	ALUMINUM	WHITE	PRICE ASCDA, TITUS TMSA-AA, LAY-IN SQUARE CEILING DIFF
С	230-320	24"X24"	10"ø	ALUMINUM	WHITE	PRICE ASCDA, TITUS TMSA-AA, LAY-IN SQUARE CEILING DIFF
D	320-600	24"X24"	12"ø	ALUMINUM	WHITE	PRICE ASCDA, TITUS TMSA-AA, LAY-IN SQUARE CEILING DIFF
E	0-120	11"X11"	6"X6"	ALUMINUM	WHITE	PRICE AMD, TITUS TDCA, SURFACE MOUNTED SQUARE CEILING DIFF
F	120-230	14"X14"	9"X9"	ALUMINUM	WHITE	PRICE AMD, TITUS TDCA, SURFACE MOUNTED SQUARE CEILING DIFF
G	230-320	17 " X17"	12"X12"	ALUMINUM	WHITE	PRICE AMD, TITUS TDCA, SURFACE MOUNTED SQUARE CEILING DIFF
Н	0-180	8"X6"	8"ø	ALUMINUM	WHITE	PRICE 620, TITUS 300 SERIES SIDEWALL S/A GRILLE; 3 BLADE SPACING & 45 DEFLECTION
RA	0-2160	24"X24"	24"X24"	ALUMINUM	WHITE	PRICE 81, TITUS 50F, EGGCRATE GRILLE W/ ½"X½"X1" CORE
RB	0-630	12 " X12"	12"X12"	ALUMINUM	WHITE	PRICE 81, TITUS 50F, EGGCRATE GRILLE W/ ½"X½"X1" CORE
RC	0-430	14"X12"	14"X12"	ALUMINUM	WHITE	PRICE 630, TITUS 300 SERIES SIDEWALL R/A GRILLE; 3" BLADE SPACING & 45" DEFLECTION
EA	0-630	12"X12"	12"X12"	ALUMINUM	WHITE	PRICE 81, TITUS 50F, EGGCRATE GRILLE W/ ½"X½"X1" CORE


CONTRACTOR SHALL COORDINATE LOCATION OF DIFF W/ ARCHITECTURAL REFLECTIVE CEILING PLAN TO AVOID ANY CONFLICTS W/ LIGHTS, AUDIO EQUIPMENT AND OTHER CEILING APPURTENANCE.

CONTRACTOR TO PROVIDE ALL TRANSITIONS NECESSARY TO ACCOMMODATE GRILLE CONNECTION. COLOR OF DIFFUSER BY ARCHITECT.

SIDEWALL DIFFUSERS/GRILLES SHALL BE PROVIDE WITH ADJUSTABLE BLADES TO THE SHORT DIMENSION.

NOTES

ARCHESTRATE architecture + interiors + graphics

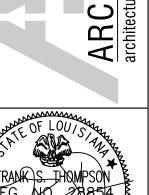



SOUTH

NO. SUBMISSION DATE 1 CONSTRUCTION SET 03/15/24

JTW DRAWN BY: CHECKED BY: FST PROJECT NUMBER: 2023.04

SHEET TITLE **MECHANICAL**

SCHEDULES




GENERAL NOTES:

- 1. ALL UNITS 2000 CFM & ABOVE SHALL BE FURNISHED WITH SMOKE DETECTOR & AUDIO/VISUAL ALARM LOCATED IN VISIBLE AREA ON NEARBY WALL. CONDENSATE DRAIN LINE SHALL BE INSTALLED WITH "P-TRAP" & SHALL BE INSULATED. CONDENSATE DRAIN LINE SHALL BE ROUTED WITH DISCHARGE TO NEAREST ROOF DRAIN/DOWNSPOUT & MUST MAINTAIN MINIMUM 2" AIR GAP BETWEEN DRAIN TERMINATION & TOP OF ROOF DRAIN/DOWNSPOUT. COORDINATE NEAREST ROOF DRAIN/DOWNSPOUT LOCATION WITH PLUMBING PLAN. CONDENSATE DRAIN LINES SHALL BE ROUTED IN SUCH A MANNER AS TO NOT BLOCK
- OR OBSTRUCT ANY ACCESS (FILTER, COOLING COIL, FAN, ETC.) TO PACKAGED UNIT. OUTSIDE AIR INTAKE HOOD TO BE FURNISHED & INSTALLED WITH INSECT SCREE & A FULLY MODULATING (0-100%) DAMPER. ALL UNITS WITH A TOTAL COOLING CAPACITY OF 54,000 BTUH & ABOVE TO BE INSTALLED WITH ECONOMIZER. ECONOMIZER WILL BE CONTROLLED THROUGH DIFFERENTIAL ENTHALPY CONTROL. HIGH LIMIT SHUTOFF TO BE SET SUCH THAT WHEN THE OUTDOOR AIR ENTHALPY EXCEEDS THE RETURN AIR ENTHALPY, THE ECONOMIZER WILL BE OFF. WHEN THE ECONOMIZER IS SET TO OFF, THE DAMPER SHALL MODULATE DOWN TO THE SET DESIGN MINIMUM OUTDOOR AIR QUANTITY. 4. WHEN PROVIDED WITH ECONOMIZER, UNIT TO BE FURNISHED & INSTALLED WITH BAROMETRIC RELIEF DAMPER TO MAINTAIN BUILDING PRESSURE & TO WORK


DETAIL - PACKAGED DX UNIT W/ ELECTRIC HEAT

NO SCALE

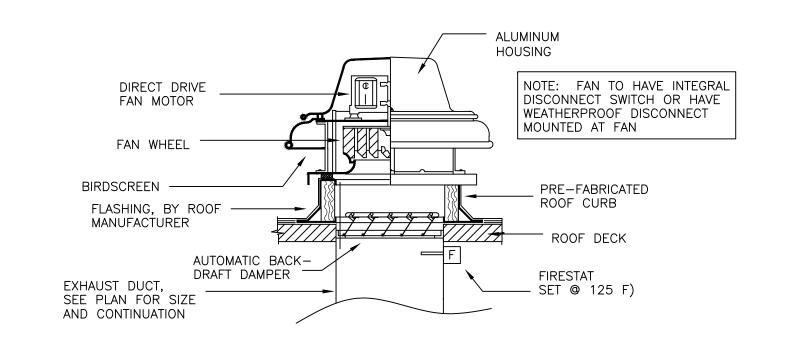


1 DETAIL - ROOF MOUNTED DOWNBLAST EF

NO SCALE

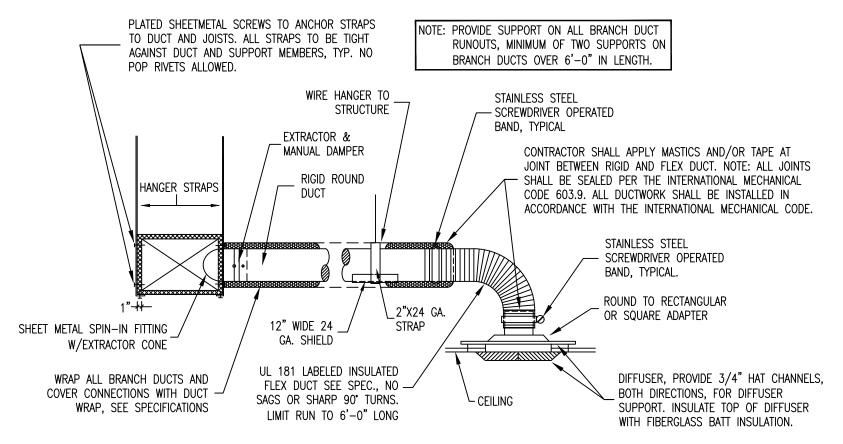


7 DETAIL - DIFFUSER CONNECTION

NO SCALE

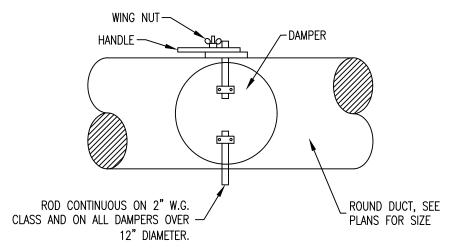


10 DETAIL - ROUND M.V.D.

NO SCALE

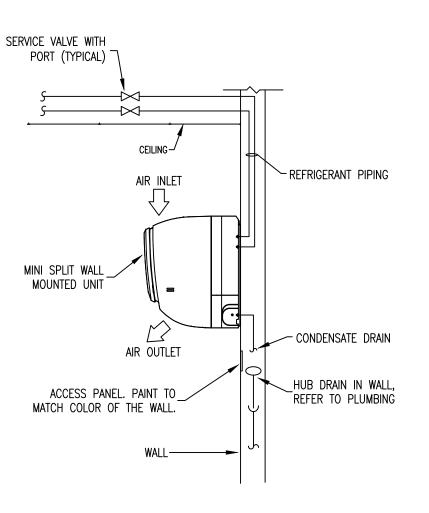


2 DETAIL - WALL MOUNT MINISPLIT UNIT

NO SCALE

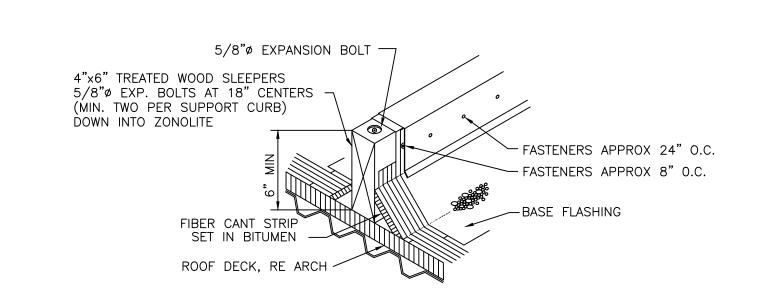

5 DETAIL - ROOF-MOUNTED SUPPORT CURB

NO SCALE

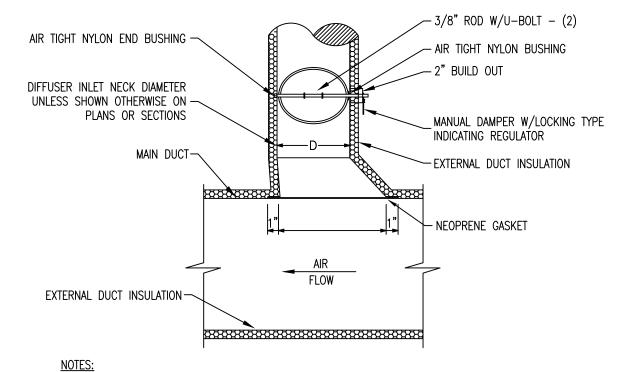


NOTES:
1. THIS DETAIL IS FOR EXTERNALLY INSULATED DUCTWORK.

- 2. EXTEND ROUND SHEETMETAL DUCTWORK AND ASSOCIATED DUCT INSULATION FROM MAIN DUCT, SO FLEXIBLE DUCT LENGTH DOES NOT EXCEED 6 FEET.
- 3. FLEX DUCT: FLEXMASTER TYPE 8M-R6, OR APPROVED EQUAL SUBMIT SAMPLE FOR APPROVAL


DETAIL - EXTRACTOR & MANUAL DAMPER

NO SCALE

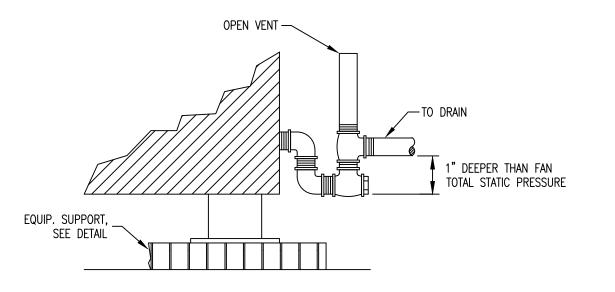

DETAIL - CONDENSATE DRAIN

NO SCALE

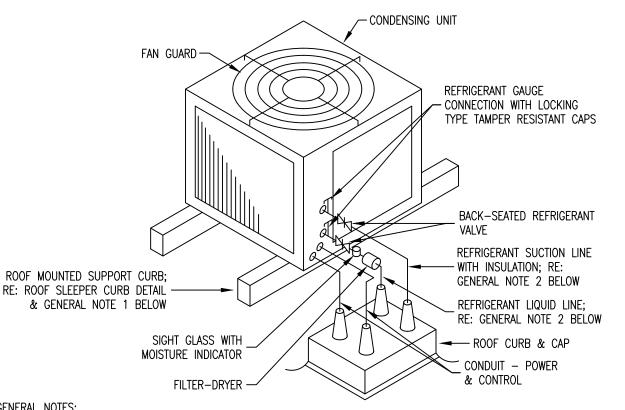


GENERAL NOTES:

- 1. CONDENSING UNIT SHALL BE INSTALLED ON ROOF MOUNTED SUPPORT CURBS (SLEEPERS). CONDENSING UNIT SHALL BE LOCATED WITH A MINIMUM 3'-0" CLEARANCE BETWEEN UNITS & MINIMUM 10'-0" FROM ANY ROOF EDGE.
- 2. ALL REFRIGERANT LINES MUST BE SIZED IN STRICT ACCORDANCE WITH MANUFACTURER'S SPECIFICATIONS. REFRIGERANT LINES SHALL BE ROUTED UP EXTERIOR WALL & EXPOSED THROUGH ATTIC OR CEILING SPACE TO RESPECTIVE AIR HANDLING UNIT. SEAL


3 DETAIL - ROOF MOUNT AIR COOLED CU

NO SCALE

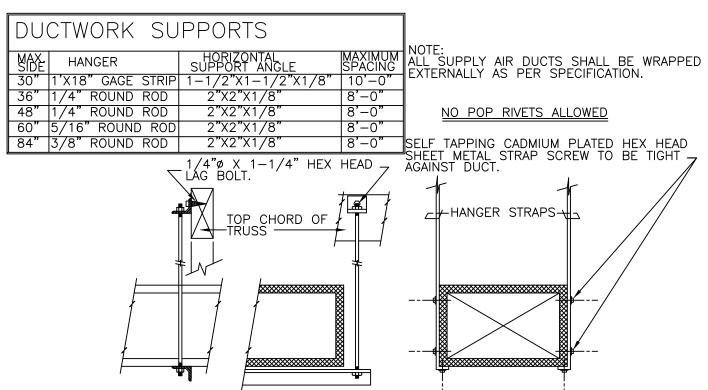

6 DETAIL - DUCTWORK SUPPORTS

NO SCALE

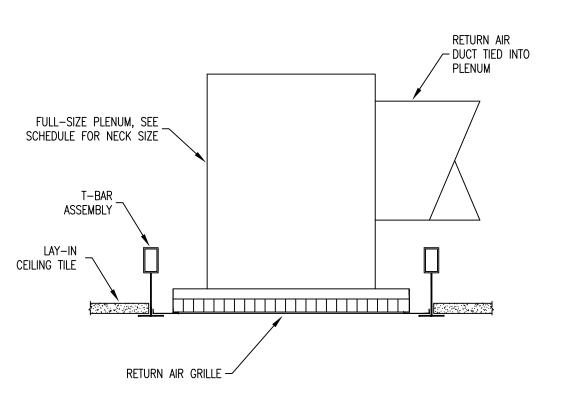

9 DETAIL - RETURN GRILLE PLENUM

NO SCALE

NO. SUBMISSION DATE CONSTRUCTION SET 03/15/24

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JTW FST CHECKED BY:

PROJECT NUMBER: 2023.04 SHEET TITLE


MECHANICAL DETAILS



DEMO PLUMBING PLAN NOTES

- REMOVE EXISTING WATER CLOSET. TEMPORARILY CAP EXISTING DOMESTIC WATER & SANITARY SEWER CONNECTIONS & PREPARE FOR INSTALLATION OF NEW WATER CLOSET. RE: NEW PLAN.
- REMOVE EXISTING LAVATORY. TEMPORARILY CAP EXISTING DOMESTIC WATER & SANITARY SEWER CONNECTIONS & PREPARE FOR INSTALLATION OF NEW LAVATORY. RE: NEW PLAN.
- REMOVE EXISTING JANITOR SINK. TEMPORARILY CAP EXISTING DOMESTIC WATER & SANITARY SEWER CONNECTIONS & PREPARE FOR INSTALLATION OF NEW JANITOR SINK. RE: NEW PLAN.
- REMOVE EXISTING URINAL. TEMPORARILY CAP EXISTING DOMESTIC WATER & SANITARY SEWER CONNECTIONS & PREPARE FOR INSTALLATION OF NEW URINAL. RE: NEW PLAN.
- REMOVE EXISTING HOT & COLD WATER TAPS & ASSOCIATED SANITARY SEWER. CAP DOMESTIC WATER ABOVE CEILING & SANITARY SEWER BELOW SLAB & PATCH FLOOR. COORDINATE W/ ARCHITECT FOR EXACT FINISH OF FLOOR.



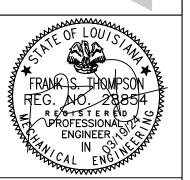

NO. SUBMISSION DATE 1 CONSTRUCTION SET 03/15/24

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> **DEMO PLUMBING** PLAN

THOMPSON LUKE & ASSOCIATES, L.L.C.
10705 RIEGER RD., STE 101
BATON ROUGE, LA 70809
(225)293-9474 TLA PROJECT #23-282
Frank Saville Thompson - License No. 28854
Landon David Burns - License No. 46484

1/8" = 1'-0"




SANITARY SEWER PLAN NOTES

- 1) 4"W., 3"V. TO SERVE WATER CLOSET, TYPICAL.
- 2"W., 2"V. TO SERVE LAVATORY/SINK, TYPICAL.
- (3) 3"W., 2"V. TO SERVE FLOOR DRAIN, TYPICAL.
- (4) 3"W., 2"V. TO SERVE JANITOR'S SINK, TYPICAL.
- (5) 2"W., 2"V. TO SERVE URINAL. TIE INTO EXISTING SANITARY SEWER IN SAME LOCATION. VERIFY EXISTING CONDITIONS PRIOR TO INSTALLATION.
- (6) 4"W., 3"V. TO SERVE WATER CLOSET. TIE INTO EXISTING SANITARY SEWER IN SAMÉ LOCATION. VERIFY EXISTING CONDITIONS PRIOR TO INSTALLATION.
- (7) 2"W., 2"V. TO SERVE LAVATORY/SINK. TIE INTO EXISTING SANITARY SEWER IN APPROXIMATE LOCATION. VERIFY EXISTING CONDITIONS PRIOR TO INSTALLATION. CONTRACTOR SHALL EXTEND SANITARY SEWER IN WALL AS REQUIRED TO ACCOMMODATE INSTALLATION OF NEW FIXTURE IN NEW LOCATION. MODIFY WALL AS REQUIRED AND PATCH TO MATCH EXISTING. COORDINATE FINISHES WITH ARCHITECT.
- (8) 3"W., 2"V. TO SERVE JANITOR'S SINK. TIE INTO EXISTING SANITARY SEWER IN SAME LOCATION. VERIFY EXISTING CONDITIONS PRIOR TO INSTALLATION.
- (9) 2"W, 2"V. TO SERVE 4" HUB DRAIN IN WALL FOR MECHANICAL CONDENSATE. PROVIDE ACCESS PANEL.
- 10 CONTRACTOR SHALL SAWCUT EXISTING SLAB AS REQUIRED TO ACCOMMODATE INSTALLATION OF NEW PLUMBING.

PLUMBING LEGEND	(SANITA	ARY SEWER)
SYMBOL	ABBREVIATION	DECRYPTION
	w	SANITARY WASTE PIPE AND SIZE
AND THE RESERVE OF THE PARTY OF	٧	SANITARY VENT PIPE AND SIZE
$\overline{}$	со	CLEAN OUT
— →	FD	FLOOR DRAIN AND SIZE
	HD	HUB DRAIN AND SIZE
1	_	PLUMBING PLAN NOTE
•	_	POINT OF CONNECTION



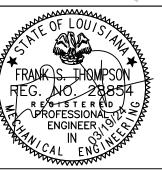

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PROJECT NUMBER: 2023.04

SANITARY SEWER PLAN


THOMPSON LUKE & ASSOCIATES, L.L.C. 10705 RIEGER RD., STE 101





DOMESTIC WATER PLAN NOTES

- 1) 1" CW TO SERVE WATER CLOSET, TYPICAL.
- (2) $\frac{1}{2}$ " H&CW TO SERVE LAVATORY/SINK, TYPICAL.
- (3) 3" TRAP PRIMER TO SERVE FLOOR DRAIN, TYPICAL.
- $\frac{1}{2}$ H&CW TO SERVE JANITOR'S SINK, TYPICAL.
- (5) 1" CW TO SERVE WATER CLOSET. TIE INTO EXISTING DOMESTIC COLD WATER IN SAME LOCATION. VERIFY EXISTING CONDITIONS PRIOR TO INSTALLATION. TYPICAL.
- (6) ½" H&CW TO SERVE LAVATORY/SINK. TIE INTO EXISTING DOMESTIC COLD WATER ÍN SAME LOCATION. VERIFY EXÍSTING CONDITIONS PRIOR TO INSTALLATION.
- 7 $\frac{1}{2}$ H&CW TO SERVE JANITOR'S SINK. TIE INTO EXISTING DOMESTIC COLD WATER IN SAME LOCATION. VERIFY EXISTING CONDITIONS PRIOR TO INSTALLATION. TYPICAL.
- (8) 3 CW TO SERVE URINAL. TIE INTO EXISTING DOMESTIC COLD WATER IN SAME LOCATION. VERIFY EXISTING CONDITIONS PRIOR TO INSTALLATION. TYPICAL.
- (9) TIE NEW DOMESTIC HOT & COLD WATER INTO NEAREST EXISTING BUILDING SERVICES OF SUFFICIENT SIZE. VERIFY EXISTING TIE IN LOCATION & SIZE OF EXISTING PRIOR TO CONSTRUCTION.
- (10) ½" CW DN TO SERVE REFRIGERATOR VALVE BOX, TYPICAL.
- (11) EXISTING ELECTRIC WATER HEATER TO REMAIN. CONTRACTOR SHALL CLEAN & SERVICE, VERIFY WATER HEATER IS IN PROPER WORKING ORDER.
- (12) NEW HOT WATER RECIRCULATION PUMP, B&G ECOCIRC XL N20-35. PUMP DATA: 28 GPM @ 11' HEAD, 1/12 HP, 120V/1\phi/60. INSTALL IN STRICT ACCORDANCE TO MANUFACTURER'S
- 13) TIE NEW 3" HWR INTO EXISTING DOMESTIC WATER SUPPLY TO WATER HEATER. VERIFY EXACT TIE IN LOCATION PRIOR TO INSTALLATION. PROVIDE SHUT-OFF

PLUMBING LEGEND	(DOMES	STIC WATER)
SYMBOL	ABBREVIATION	DECRYPTION
	DCW	DOMESTIC COLD WATER PIPE
	DHW	DOMESTIC HOT WATER PIPE
1/2"	-	PIPE SIZE
─ -───	-	SHUT OFF VALVE (SAME SIZE AS PIPE IF NOT SPECIFICED)
C+	-	PIPE DOWN
0+	-	PIPE UP
<u> </u>	-	PIPE TEE
t	_	PIPE ELL
	_	PIPE TEE UP
	_	PIPE TEE DOWN
<u></u>	_	PIPE CONTINUES
<i>VIII</i> 2	VB	VALVE BOX IN WALL
1	_	PLUMBING PLAN NOTE

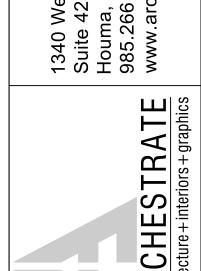

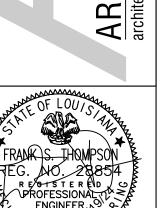

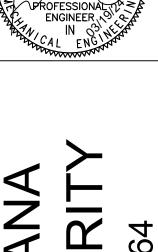

SON

NO. SUBMISSION DATE CONSTRUCTION SET 03/15/24

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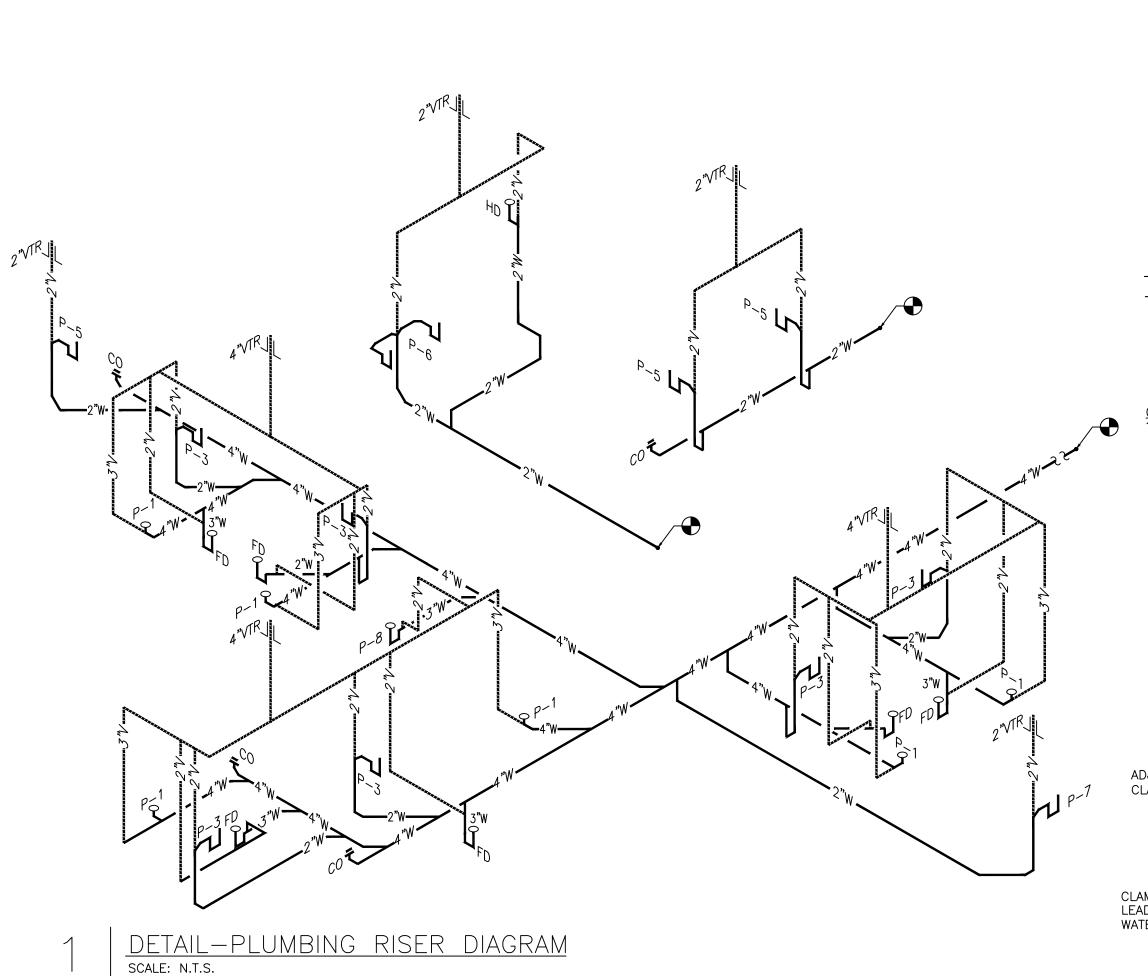
DOMESTIC WATER PLAN


DOMESTIC WATER PLAN

Landon David Burns - License No. 46484

THOMPSON LUKE & ASSOCIATES, L.L.C. 10705 RIEGER RD., STE 101 BATON ROUGE, LA 70809 (225)293-9474 TLA PROJECT #23-282 Frank Saville Thompson - License No. 28854

		MANUFACTURER &				RIM			CC	NNEC	TION	SIZE
TAG	FIXTURE DESCRIPTION	MODEL NUMBER	FLUSHVALVE	SEAT	CARRIER	FAUCET	DRAIN	MISCELLANEOUS				AN. VENT NOTES
P-1	FLOOR MOUNTED WHITE VITREOUS CHINA WATER CLOSET WITH TOP SPUD AND MANUAL FLUSH VALVE (1.6 GPF); ADA COMPLIANT	AMERICAN STANDARD 3461.001 KOHLER K-4368 ZURN Z5665-BWL	SLOAN MODEL 111 ZURN Z6000	BENEKE 527 SS CHURCH 9500 SSC					1"		- 4	4" 3"
P-2	FLOOR MOUNTED WHITE VITREOUS CHINA WATER CLOSET WITH TOP SPUD AND MANUAL FLUSH VALVE (1.6 GPF)	AMERICAN STANDARD 2234.001 KOHLER K-4350 ZURN Z5655-BWL	SLOAN MODEL 111 ZURN Z6000	BENEKE 527 SS CHURCH 9500 SSC					1"		- 4	3"
P-3	20"X18" WHITE VITREOUS CHINA WITH OVERFLOW WALL HUNG LAVATORY WITH 4" CENTER FAUCET HOLES	AMERICAN STANDARD 0124.131 KOHLER K-1729 ZURN Z5344			JAY R. SMITH 0700-Z ZURN Z1231 JOSAM 17100	AMERICAN STANDARD 7385.003 T&S BRASS B-2711 ZURN Z81000-G		1½" CAST BRASS "P" TRAP W/ CLEAN OUT; %" ANGLE STOP SUPPLIES WITH LOOSE KEY STOP	1/2"	1/2'	, 2	CONTRACTOR SHALL COORDINATE EXACT CONCEALED ARM SUPPORT WALL CARRIER WITH WALL THICKNESS THAT LAVATORY OCCURS ON.
P-4	20"X17" WHITE VITREOUS CHINA SELF—RIMMING WITH FRONT OVERFLOW COUNTERTOP LAVATORY WITH 4" CENTER FAUCET HOLES	AMERICAN STANDARD 0476.028 KOHLER K-2196 ZURN Z5114				AMERICAN STANDARD 7385.003 T&S BRASS B-2711 ZURN Z81000-G		1½" CAST BRASS "P" TRAP W/ CLEAN OUT; %" ANGLE STOP SUPPLIES WITH LOOSE KEY STOP	1/2"	1/2'	, 2	2" 2"
P-5	22"X19" SINGLE BOWL STAINLESS STEEL TYPE 304 CLASSROOM SINK WITH SINGLE HOLE HIGH GOOSENECK FAUCET	ELKAY LR2219 JUST SL-1921-A-GR				ELKAY LKD2223 JUST JGN-750	ELKAY LK-35 JUST J-35	1½" CAST BRASS "P" TRAP W/ CLEAN OUT; ¾" ANGLE STOP SUPPLIES WITH LOOSE KEY STOP	1/2"	1/2	" 2	2" 2"
P-6	33"X19" TOP MOUNT SELF RIMMING 18 GA. TYPE 304 STAINLESS STEEL DOUBLE COMP. SINK W/ 3 HOLE FAUCET ON 4" CENTERS	ELKAY LR3319 JUST DL-1933-A-GR				ELKAY LKE4102 JUST J-900	ELKAY LK-35 JUST J-35	1½" CAST BRASS "P" TRAP W/ CLEAN OUT; ¾" ANGLE STOP SUPPLIES WITH LOOSE KEY STOP	1/2"	1/2'	" 2	2" 2"
P-7	22"X19" SINGLE BOWL STAINLESS STEEL TYPE 304 CLASSROOM SINK WITH SINGLE HOLE HIGH GOOSENECK FAUCET	ELKAY LR2219 JUST SL-1921-A-GR				ELKAY LKD2223 JUST JGN-750	ELKAY LK-35 JUST J-35	1½" CAST BRASS "P" TRAP W/ CLEAN OUT; ¾" ANGLE STOP SUPPLIES WITH LOOSE KEY STOP	1/2"	1/2	" 2	2" 2"
P-8	24"X24"X12" SERVICE SINK BASIN WITH STAINLESS STEEL FRONT CAP AND STAINLESS STEEL BACKSPLASH	FIAT TSB 3000 ACORN TDF-24 STERM WILLIAMS HL-1800				ZURN Z1996-SF FIAT 830-AA			1/2"	1/2'	"	2" PROVIDE HOSE W/BRACKET TO SUPPORT HOSE & MOP HANGER FOR EASY STORAGE OF THE MOP OVER SINK.
P-9	WALL MOUNTED WHITE VITREOUS CHINA URINAL WITH MANUAL FLUSH VALVE, WASHOUT FLUSH ACTION(1.0 GPF) AND EXTENDED SIDES FOR PRIVACY; ¾" TOP SPUD	AMERICAN STANDARD 6501.010 KOHLER K-4960-ET ZURN Z5750	SLOAN CROWN MODEL 186-1.0 ZURN AQUAFLUSH Z6003-WS1		JAY R. SMITH 0615 JOSAM 17560-UR ZURN Z1222				3/4"		- 2	URINAL IS ADA COMPLIANT WHEN MOUNTED NO HIGHER THAN 17" ABOVE FINISHED FLOOR
FD	CAST IRON FLOOR DRAIN WITH ½" TRAP PRIMER CONNECTION AND ADJUSTABLE SQUARE NICKEL BRONZE STRAINER	JAY R. SMITH 2005 WADE 1100G ZURN Z415S									- -	ALL FLOOR DRAINS SHALL BE INSTALLED WITH ½" TRAP PRIMER. SEE PLANS FOR SANITARY SEWER AND VENT CONNECTION SIZES.




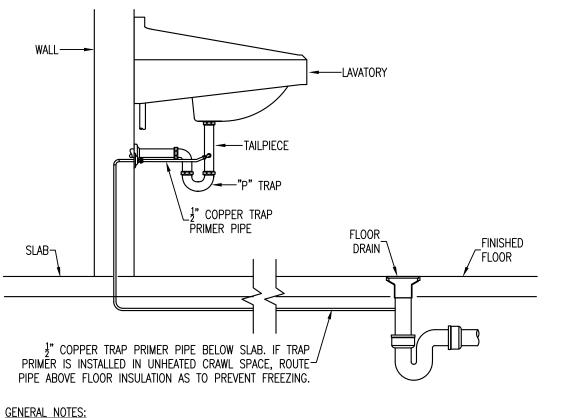

GENERAL NOTES:


1. ALL COPPER PIPING BELOW SLAB MUST BE SOFT DRAWN WITH NO JOINTS. ALL COPPER PIPING ABOVE SLAB MUST BE HARD DRAWN COPPER.

DETAIL-GRAVITY TRAP PRIMER scale: n.t.s.

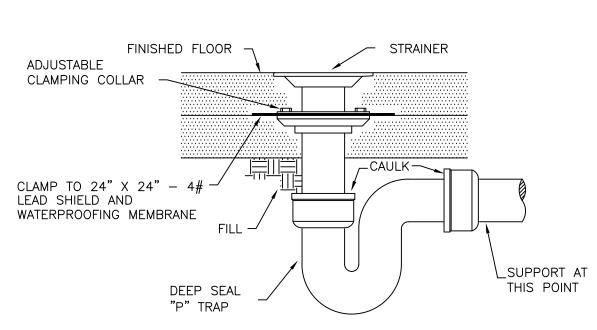


ALL FLOOR DRAINS SHALL HAVE TRAP PRIMERS.

5 DETAIL-FLOOR DRAIN

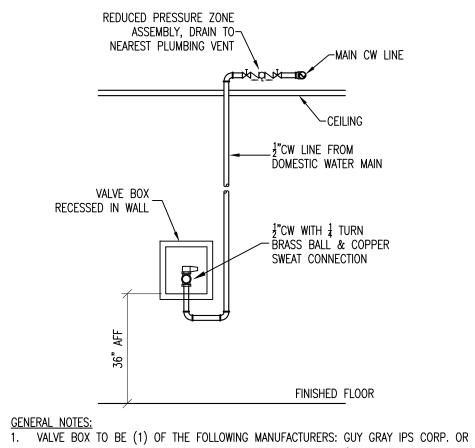

VALVE BOX TO BE (1) OF THE FOLLOWING MANUFACTURERS: GUY GRAY IPS CORP. OR
 OATEY. VALVE BOX TO BE POWDER COATED METAL BOX WITH ¹/₄" TURN BRASS BALL
 VALVE, COPPER SWEAT CONNECTION, & METAL MOUNTING BRACKETS & FACEPLATE.
 REDUCED PRESSURE ZONE ASSEMBLY TO BE (1) OF THE FOLLOWING MANUFACTURERS:
 WATTS LF009 OR ZURN 975XL2. ASSEMBLY MUST BE LEAD FREE & EASILY ACCESSIBLE.

DETAIL-REFRIGERATOR VALVE BOX scale: N.T.S.

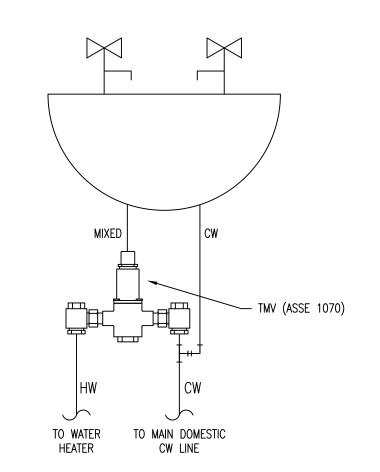


GENERAL NOTES:

1. CONTRACTOR SHALL PROVIDE & INSTALL MIFAB MI—THERM OR LEONARD 170—LF THERMOSTATIC MIXING VALVE IN STRICT ACCORDANCE WITH MANUFACTURER'S SPECIFICATIONS.

2. MIXING VALVE MUST BE CERTIFIED TO A.S.S.E 1070 STANDARD.

DETAIL-ASSE 1070 TMV

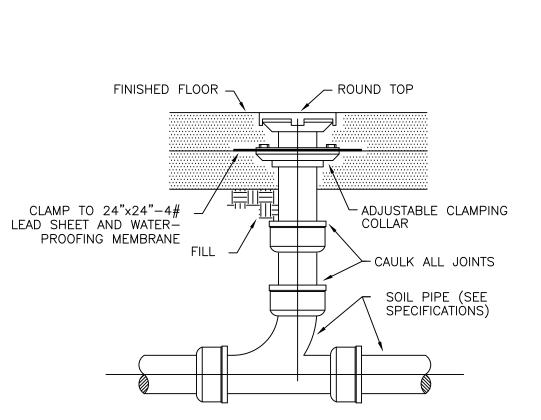

4 DETAIL-INTERIOR FLOOR CLEANOUT scale: n.t.s.

NO. SUBMISSION DATE

1 CONSTRUCTION SET 03/15/24

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DRAWN BY: JTW
CHECKED BY: FST

PROJECT NUMBER: 2023.04
SHEET TITLE

PLUMBING SCHEDULES & DETAILS

FFT NO

P200

THOMPSON LUKE & ASSOCIATES, L.L.C.
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(225)293-9474 TLA PROJECT #23-282
Frank Saville Thompson - License No. 28854
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FIRE PROTECTION LEGEND:

- CONCEALED POPOUT TYPE SPRINKLER HEAD
- PENDANT TYPE SPRINKLER HEAD

 LOCATED DEFLECTOR AT BOTTOM OF JOIST BUT NOT GREATER
 THAN 18" BELOW CEILING
- UPRIGHT PENDANT TYPE SPRINKLER HEAD


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GENERAL FIRE PROTECTION NOTES:

- COORDINATE EXACT LOCATION OF ALL SPRINKLER PIPING MAINS & HEADS WITH ARCHITECTURAL FLOOR PLAN, ELECTRICAL LIGHTING PLAN, PLUMBING AND MECHANICAL FLOOR PLANS.
- 2. SPRINKLER HEAD LAYOUT AND PIPING ARE SHOWN IN APPROXIMATE LOCATIONS. EXACT NUMBER OF HEADS REQUIRED, PIPING SIZE, ETC. SHALL BE AS SUBMITTED IN THE SPRINKLER SHOP DRAWINGS AND HYDRAULIC CALCULATIONS SUBMITTAL TO THE STATE FIRE MARSHAL.
- 3. H.V.A.C. EQUIPMENT, SUPPLY DUCT, EXHAUST DUCT AND PIPING SHALL HAVE PRECEDENCE IN DETERMINING EXACT HEIGHT AD LOCATION FOR ALL SPRINKLER HEADS AND PIPING MAINS. SPRINKLER HEADS TO BE CENTERED IN CEILING TILE.
- 4. FIRE PROTECTION CONTRACTOR IS REQUIRED TO PROVIDE AND INSTALL SPRINKLER HEADS FOR COMPLETE COVERAGE ABOVE AND BELOW THE CEILING IN ALL AREAS. REFER TO ARCHITECTURAL PLANS FOR BUILDING SECTIONS. SEE NOTE NO. 5.
- 5. SPRINKLER HEADS INDICATED ON THE PLANS ARE SHOWN AS CONCEALED POP OUT TYPE SPRINKLER HEADS FOR ALL OCCUPIED AREAS. PROVIDE CHROME PENDANT TYPE AND/OR UPRIGHT IN UNOCCUPIED AREAS SUCH AS ABOVE CEILING SPACE, MECHANICAL ROOMS, AND AREAS WITH EXPOSED STRUCTURE.
- 6. FIRE PROTECTION CONTRACTOR IS REQUIRED TO PROVIDE AND INSTALL SPRINKLER HEADS FOR COMPLETE COVERAGE ABOVE AND BELOW THE CEILING IN ALL AREAS ON THE FIRST FLOOR AND ATTIC. REFER TO ARCHITECTURAL PLANS FOR BUILDING SECTIONS. SEE NOTE NO. 5.

CONTRACTOR SHALL RELOCATE EXISTING AND/OR PROVIDE NEW SPRINKLER HEADS TO ACCOMMODATE NEW FLOOR PLAN.
COORDINATE W/ ARCHITECTURAL CEILING PLAN FOR EXACT HEAD LOCATIONS. HEAD LAYOUT SHALL BE IN COMPLIANCE TO NEPA 96.

ARCHESTRATE

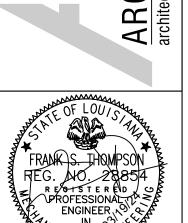

ENTRAL LOUISIANA FRVICES AUTHORITY W ST. HOUMA, LA 70364

NO. SUBMISSION DATE

1 CONSTRUCTION SET 03/15/24

SOU

DRAWN BY: JTW

CHECKED BY: FST

PROJECT NUMBER: 2023.04

FIRE PROTECTION

PLAN

CUEET NO

SHEET NO.

1 FIRE PROTECTION PLAN

1/8" = 1'-0"


THOMP 10705 RIEC BATON RC (225)293-9 Ergals Squi


THOMPSON LUKE & ASSOCIATES, L.L.C. 10705 RIEGER RD., STE 101
BATON ROUGE, LA 70809
(225)293-9474 TLA PROJECT #23-282
Frank Saville Thompson - License No. 28854

Landon David Burns - License No. 46484

=P100



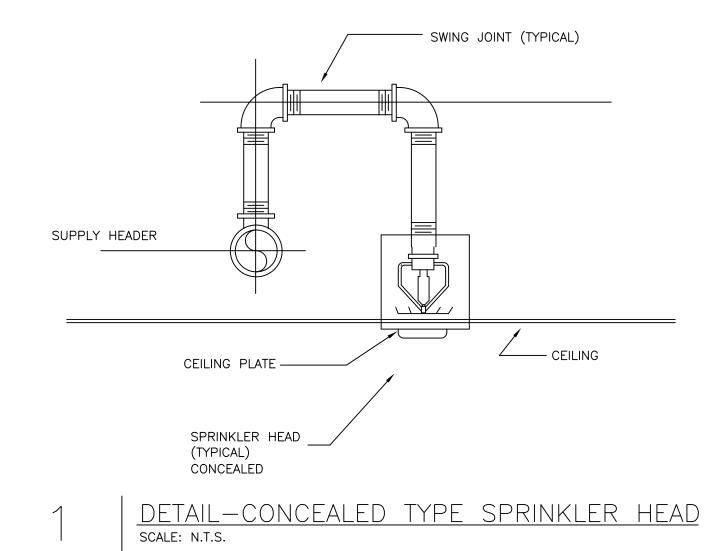

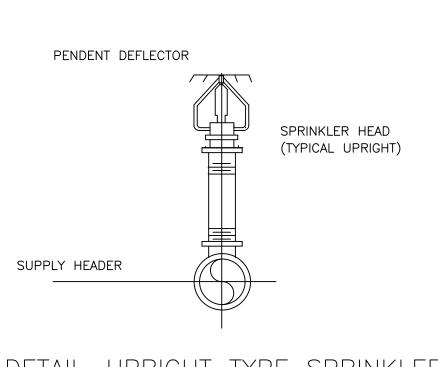

DETAIL-UPRIGHT TYPE SPRINKLER HEAD scale: N.T.S.

DETAIL-PENDANT TYPE SPRINKLER HEAD scale: n.t.s.

SUPPLY HEADER

CEILING PLATE

SPRINKLER HEAD (TYPICAL)

— SWING JOINT (TYPICAL)

CEILING

— PENDANT DEFLECTOR

NO. SUBMISSION DATE 1 CONSTRUCTION SET 03/15/24

> JTW DRAWN BY: CHECKED BY: FST

PROJECT NUMBER: 2023.04

FIRE PROTECTION DETAILS



WIRE, CONDUIT, AND RACEWAY

ABOVE-SLAB CONDUIT & WIRE/CABLING — — — BELOW-SLAB CONDUIT & WIRE/CABLING: 3/4" MINIMUM CONDUIT SIZE UON

HOMERUN TO PANEL: TICK MARKS INDICATED NUMBER OF WIRES

DISTRIBUTION

PANELBOARD, SWITCHBOARD, OR OTHER DISTRIBUTION EQUIPMENT AS NOTED; INSTALL WITH SUFFICIENT WORKING SPACE AND CLEARANCES TO MEET ALL REQUIREMENTS OF NEC SECTION 110.26.

GENERATOR REMOTE ANNUNCIATOR PANEL; PROVIDE CONDUIT/CABLING TO GENERATOR AS REQUIRED PER THE MANUFACTURER'S SPECIFICATIONS.

EQUIPMENT CONNECTIONS (PROVIDE CONDUIT AND WIRE PER THE PANEL SCHEDULE)

FUSED SAFETY DISCONNECT SWITCH; LOCATE WITHIN SIGHT OF THE EQUIPMENT SERVED WITH 36" MINIMUM CLEAR WORKING SPACE IN FRONT OF THE SWITCH; DO NOT MOUNT DIRECTLY TO EQUIPMENT

JUNCTION BOX

JUNCTION BOX FOR MOTORIZED DAMPER

MOTOR RATED SWITCH WITH THERMAL OVERLOAD; LOCATE WITHIN SIGHT OF THE EQUIPMENT SERVED; DO NOT MOUNT DIRECTLY TO EQUIPMENT, WHEN LOCATED ABOVE CEILING, MOUNT TO STRUCTURAL MEMBER NEARBY.

VIDE CONDUIT AND WIRE PER THE PANEL SCHEDULE)

DUPLEX RECEPTACLE

ABOVE-COUNTER DUPLEX RECEPTACLE; MOUNT AT 4" ABOVE COUNTER OR BACKSPLASH OR 44" (WHICHEVER IS LOWER)

GFCI DUPLEX RECEPTACLE

ABOVE-COUNTER GFCI DUPLEX RECEPTACLE; MOUNT AT 4" ABOVE COUNTER OR BACKSPLASH OR 44" (WHICHEVER IS LOWER)

QUADRAPLEX RECEPTACLE

ABOVE-COUNTER QUADRAPLEX RECEPTACLE; MOUNT AT 4" ABOVE COUNTER OR BACKSPLASH OR 44" (WHICHEVER IS LOWER)

> SPECIAL PURPOSE RECEPTACLE: VERIFY NEMA CONFIGURATION WITH THE MANUFACTURER OF THE EQUIPMENT SERVED

(JACKET COLORS TO BE PER THE OWNER'S STANDARDS IF APPLICABLE)

TELECOM TERMINAL BOARD; 0'-1" THICK AC INDOOR GRADE, FIRE RETARDANT PLYWOOD, PAINTED AS SPECIFIED BY THE ARCHITECT OR OWNER


DUPLEX DATA OUTLET; REFER TO TELECOMMUNICATIONS NOTES FOR MORE INFORMATION. PROVIDE (2) CABLES UNLESS INDICATED OTHERWISE BY NUMBER ADJACENT TO SYMBOL.

WIRELESS ACCESS POINT (BY OWNER): PROVIDE 1"C TO AN ACCESSIBLE LOCATION ABOVE CEILING, ONE (1) YELLOW CAT 6 CABLE FROM THE ACCESS POINT LOCATION TO THE TELECOM TERMINAL BOARD

LEGRAND EVOLUTION 4-GANG OR APPROVED EQUAL TV WALL BOX WITH ONE DUPLEX RECEPTACLE, ONE DUPLEX DATA OUTLET, ONE COAX OUTLET, AND ONE HDMI OUTLET; PROVIDE 1"C, TWO (2) BLUE CAT 6 CABLES AND 1"C, ONE (1) CATV CABLE FROM THE BOX TO THE TELECOM TERMINAL BOARD; PROVIDE CONDUIT AND WIRE FOR POWER PER THE PANEL SCHEDULE.

LEGRAND EVOLUTION 4-GANG OR APPROVED EQUAL COMBO RECESSED FLOOR BOX WITH TWO (2) DUPLEX RECEPTACLES. FOUR (4) DATA OUTLETS (UNDER A SINGLE PLATE), AND HDMI; PROVIDE 1-1/4"C TO AN ACCESSIBLE LOCATION ABOVE CEILING, FOUR (4) BLUE CAT 6 CABLES FROM THE BOX TO THE TELECOM TERMINAL BOARD. ROUTE 1"C WITH HDMI CABLE FROM THE BOX TO THE TV WALL BOX IN THE SAME ROOM. PROVIDE CONDUIT AND WIRE FOR POWER PER THE PANEL SCHEDULE.

PROVIDE CONDUIT AND WIRE PER THE PANEL SCHEDULE FOR POWER AND PER THE MANUFACTURER'S SPECIFICATIONS FOR CONTROLS)

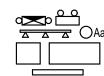

LIGHT FIXTURE; UPPERCASE LETTER(S) INDICATE FIXTURE TYPE; LOWERCASE LETTER(S) INDICATE ASSOCIATED CONTROLS ID; FIXTURES WITH HALFSHADED REGION SHALL BE EMERGENCY PROVIDE BATTERY BACKUP OR CONNECT TO EMERGENCY CIRCUIT AS INDICATED; SEE LIGHTING FIXTURE SCHEDULE FOR FIXTURE DESCRIPTIONS AND MOUNTING TYPES

EXIT LIGHT FIXTURE. ARROWS (IF USED) INDICATE DIRECTION. FILLED IN QUADRANT(S) INDICATE NUMBER AND ORIENTATION OF ILLUMINATED FACES. LETTER(S) INDICATE FIXTURE TYPE. SEE LIGHTING FIXTURE SCHEDULE FOR FIXTURE DESCRIPTION.

CEILING MOUNTED OCCUPANCY SENSOR WITH 360° COVERAGE. LOCATE AND INSTALL PER THE MANUFACTURER'S RECOMMENDATIONS; TEST AND ADJUST SENSITIVITY AFTER INSTALLATION AND SET TIME DELAY AS REQUIRED BY THE OWNER

CEILING MOUNTED OCCUPANCY SENSOR, AS ABOVE, CONFIGURED FOR VACANCY OPERATION PHOTOELECTRIC CELL, EXTERIOR RATED; AIM AND SHIELD SENSOR FROM INTERIOR AND EXTERIOR

ARTIFICIAL LIGHT SOURCES

ENCLOSED CIRCUIT BREAKER

SUBSCRIPT (WHEN USED): NONE - SINGLE POLE TOGGLE SWITCH 3 - THREE-WAY SWITCH D - LINEAR SLIDE DIMMER SWITCH 3D - THREE-WAY LINEAR SLIDE DIMMER SWITCH O - WALL MOUNTED OCCUPANCY SENSOR 30 - THREE-WAY SWITCH WITH OCCUPANCY SENSOR V- VACANCY SENSOR a,b,c etc. - SWITCH ID

FULL LOAD AMPERE(S)

(REFER TO DRAWINGS AND SPECIFICATIONS FOR FURTHER REQUIREMENTS)

FIRE ALARM
(PROVIDE CONDUIT AND WIRE PER THE PANEL SCHEDULE FOR POWER

FIRE ALARM CONTROL PANEL

FIRE ALARM SYSTEM PULL STATION

FIRE DOOR MAGNETIC HOLD OPEN

FIRE ALARM SYSTEM CHIME/STROBE

FIRE ALARM SYSTEM HORN/STROBE

FIRE ALARM SYSTEM SPEAKER/STROBE

FIRE ALARM SYSTEM CEILING MOUNT STROBE

FIRE ALARM SYSTEM CEILING MOUNT CHIME/STROBE

FIRE ALARM SYSTEM CEILING MOUNT HORN/STROBE

FIRE ALARM SYSTEM CEILING MOUNT SPEAKER/STROBE

JUNCTION BOX FOR CARD READER; PROVIDE 3/4"EC WITH

JUNCTION BOX FOR CEILING MOUNTED CAMERA; PROVIDE

3/4"EC WITH PULL STRING FROM THE JUNCTION BOX TO

JUNCTION BOX FOR WALL MOUNTED CAMERA; PROVIDE

3/4"EC WITH PULL STRING FROM THE JUNCTION BOX TO

FIRE ALARM SYSTEM CARBON MONOXIDE DETECTOR

FIRE ALARM SYSTEM THERMAL DETECTOR

FIRE ALARM SYSTEM SMOKE DETECTOR

ACCESSIBLE LOCATION ABOVE CEILING

AN ACCESSIBLE LOCATION ABOVE CEILING

AN ACCESSIBLE LOCATION ABOVE CEILING

ELECTRICAL COVER SHEET

ELECTRICAL DEMO PLAN

ALTERNATE #3 ONE-LINE

OVERALL LIGHTING PLAN

ELECTRICAL SCHEDULES 1

ELECTRICAL SCHEDULES 2

E11.0 ELECTRICAL DETAILS

POWER PLAN - MECHANICAL

POWER PLAN ENLARGED VIEWS

OVERALL POWER PLAN

DEMOLITION ONE-LINE

BASE BID ONE-LINE

ELECTRICAL SHEET INDEX

E2.0

E3.0

E4.0

E5.0

E6.0

E7.0

E8.0

E9.0

E10.0

SECURITY (EQUIPMENT PROVIDED BY OWNER/OTHERS)

FIRE ALARM SYSTEM DUCT SMOKE DETECTOR

PULL STRING FROM THE JUNCTION BOX TO AN

FIRE ALARM SYSTEM STROBE

 \bigcirc

 $\mathbb{P} \triangleleft$

AND CONDUIT AND CABLING PER THE MANUFACTURER'S SPECIFICATIONS)

ALL ELECTRICAL WORK SHALL BE DONE IN STRICT ACCORDANCE WITH THE LATEST EDITION OF THE NATIONAL ELECTRICAL CODE AS ADOPTED BY THE AHJ.

ELECTRICAL GENERAL NOTES

THE WORDS "PROVIDE" AND "PROVIDED" AS USED HEREIN SHALL BE UNDERSTOOD TO MEAN, "PROVIDE COMPLETE IN PLACE," THAT IS "FURNISH AND INSTALL". EQUIPMENT AND MATERIAL INDICATED TO BE PROVIDED SHALL BE NEW UNLESS

OTHERWISE NOTED AND SHALL BE OF THE MOST SUITABLE GRADE FOR THE PURPOSE INTENDED. ROUTE NEW CONDUIT AND WIRING CONCEALED IN WALLS AND CEILING WHERE POSSIBLE. COORDINATE INSTALLATION OF EXPOSED CONDUIT AND WIRING WITH THE ARCHITECT.

CONTRACTOR SHALL PROVIDE ELECTRICAL SERVICE TO NEW HVAC UNITS AS FURNISHED BY THE MECHANICAL CONTRACTOR. VERIFY THE EXACT ELECTRICAL REQUIREMENTS WITH THE REVIEWED HVAC SUBMITTALS PRIOR TO

ORDERING ELECTRICAL EQUIPMENT. BEFORE INSTALLATION, CONTRACTOR SHALL SUBMIT DETAILED DRAWINGS TO THE ENGINEER FOR REVIEW COVERING

PROPOSED LOCATIONS. MOUNTING, AND ROUTING FOR ALL CONDUITS, SERVICES, FITTINGS, GROUND RODS, SUPPORTS.

CONDUIT RUNS ARE SHOWN DIAGRAMMATICALLY. CONTRACTOR SHALL ROUTE IN MOST DIRECT MANNER AVOIDING ANY OBSTRUCTIONS NOT INDICATED. CONTRACTOR SHALL BE RESPONSIBLE FOR ALL GROUNDING OF EQUIPMENT, DISCONNECT SWITCHES, PANELBOARDS,

FOUNDATIONAL STEEL, BLDG STEEL, METAL PIPING, AND TELECOMMUNICATION RACKS, ETC. REGARDLESS OF DEPICTION CONTRACTOR IS RESPONSIBLE FOR OVER-CURRENT PROTECTIVE DEVICE SHORT CIRCUIT, COORDINATION, AND ARC-

FLASH STUDIES. MATERIALS AND MANUFACTURERS NOTED ON DRAWINGS ARE TO BE USED AS BASIS OF DESIGN TO ESTABLISH QUALITY AND PERFORMANCE STANDARDS AND SHALL BE PROVIDED AS SPECIFIED. SUBSTITUTIONS WILL BE CONSIDERED WHERE SUFFICIENT PRODUCT INFORMATION IS PROVIDED TO MAKE A PROPER EVALUATION. REVIEW OF A SUBSTITUTION IS AT

THE SOLE DISCRETION OF THE PROFESSIONAL. THE CONTRACTOR SHALL SUBMIT COPIES OF THE PRODUCT DATA, SHOP DRAWINGS, ETC. OF ALL MATERIALS NOTED ON THE DRAWINGS. ALL SUBMITTED PRODUCT DATA, SHOP DRAWINGS, ETC. SHALL BE MARKED WITH THE NAME OF THE PROJECT AND SHALL BEAR THE STAMP OF APPROVAL OF THE CONTRACTOR AS EVIDENCE THAT THE MATERIAL HAS BEEN

CHECKED BY THE CONTRACTOR. DRAWINGS SPECIFIC TO THIS TRADE DO NOT LIMIT THE RESPONSIBILITY OR WORK REQUIRED BY THE CONTRACT DOCUMENTS. REFER TO DRAWINGS AND SPECIFICATIONS OF OTHER TRADES FOR COMPLETE INFORMATION PRIOR TO

WHERE CONFLICTS EXIST AMONG DRAWINGS. SPECIFICATIONS, AND EQUIPMENT SCHEDULES. THE MOST STRINGENT REQUIREMENT OR QUANTITY SHALL APPLY. NOTIFY THE ARCHITECT/ENGINEER OF ALL CONFLICTS FOR RESOLUTION OR

NO EQUIPMENT SHALL BE ORDERED OR INSTALLED UNTIL THE PROJECT ENGINEER HAS RECEIVED A COPY STAMPED "NO EXCEPTIONS TAKEN." "NO EXCEPTIONS TAKEN" DOES NOT RELIEVE THE CONTRACTOR FROM CONFORMANCE WITH THE CONTRACT, EXTEND TO QUANTITIES OR DIMENSIONS, IMPLY THAT THE EQUIPMENT CAN BE INSTALLED OR OPERATE SATISFACTORILY, THAT THE EQUIPMENT CONTAINS ALL NECESSARY COMPONENTS, OR THAT IT WILL COORDINATE WITH OTHER REVIEWED ITEMS.

OMISSION FROM THIS SHEET OF ANY ITEM SHOWN ELSEWHERE IN THE PLANS DOES NOT RELIEVE THE CONTRACTOR FROM THE RESPONSIBILITY FOR ANY ASSOCIATED WORK.

COORDINATE INSTALLATION OF NEW ITEMS AND EQUIPMENT WITH THE OWNER'S REPRESENTATIVE AND THE WORK OF OTHER TRADES. THE CONTRACTOR SHALL INCUR ALL COSTS ASSOCIATED WITH THE RELOCATION OF EQUIPMENT

CONFLICTING WITH NEW WORK BY OTHER TRADES THAT HAS NOT BEEN COORDINATED. COORDINATE ALL ASPECTS OF NEW SERVICE WITH UTILITY COMPANY AND INCLUDE ALL COSTS IN BID. ALL CONDUIT SIZES SHOWN ARE MINIMUM SIZES WHICH SHALL BE UTILIZED. CONTRACTOR SHALL VERIFY THAT ALL

SHALL BE BROUGHT TO THE ENGINEER'S ATTENTION PRIOR TO BIDDING. CONTRACTOR SHALL COORDINATE ALL CONDUIT WALL AND FLOOR PENETRATIONS WITH ALL TRADES AS REQUIRED. ALL PENETRATIONS SHALL BE SEALED WATERTIGHT.

WIRING AND CABLES UTILIZED MEET NEC FILL REQUIREMENTS PRIOR TO INSTALLATION OF CONDUIT. ANY CONFLICT

CONTRACTOR SHALL MATCH NEMA RECEPTACLE CONFIGURATION TO MATCH EQUIPMENT PLUGS. CONTRACTOR SHALL PROVIDE HOUSEKEEPING PAD UNDER ALL FLOOR MOUNTED ELECTRICAL EQUIPMENT PROVIDED IN

PROVIDE 1/4" MINIMUM DIAMETER PULL ROPE. PULL ROPE SHALL NOT BE NYLON STRING. ALL 120V, 20 AMP BRANCH CIRCUITS OVER 75' SHALL BE A MINIMUM OF #10.

FURNISH AND INSTALL ALL EXTERIOR RECEPTACLES WITH WEATHERPROOF COVERS.

PROVIDE GFCI RECEPTACLES: ALL EXTERIOR LOCATIONS

LIGHTING GENERAL NOTES

WITHIN 6' OF A SINK

VERIFY THE EXACT LOCATION OF ALL LIGHTING SWITCHES WITH THE ARCHITECT PRIOR TO ROUGH-IN. VERIFY THE EXACT LOCATION OF ALL LIGHTING FIXTURES WITH THE ARCHITECTURAL REFLECTED CEILING PLAN PRIOR TO

VERIFY THE EXACT LOCATION OF CEILING MOUNTED OCCUPANCY SENSORS WITH THE MANUFACTURER'S SPECIFICATIONS

PRIOR TO INSTALLATION FOR MAXIMUM PERFORMANCE. EMERGENCY FIXTURES AND EXIT FIXTURES SHALL BE CONNECTED TO THE NEAREST LIGHTING CIRCUIT. BRANCH CIRCUIT

WIRING TO EXIT FIXTURES AND TO BATTERY INVERTERS WITHIN FIXTURES WITH INTEGRAL BATTERY UNITS SHALL BE UNSWITCHED. CONNECTED AHEAD OF ANY CONTROL SWITCHING. WALL MOUNT TYPE "Z" FIXTURES ABOVE DOOR AS SHOWN ON DRAWINGS. COORDINATE WITH THE ARCHITECT PRIOR TO

MOUNT TYPE "EM" FIXTURES 8'-0" AFF UNLESS OTHERWISE NOTED.

VERIFY THE CEILING TYPES FOR ALL LIGHT FIXTURES TO BE FLUSH MOUNTED OR SUSPENDED AND ADJUST FIXTURE MOUNTING TYPES IN ACCORDANCE WITH THE CEILING TYPE, AS REQUIRED. CONTRACTOR SHALL PROVIDE ALL REQUIRED MOUNTING HARDWARE ALL VANITY FIXTURES SHALL BE MOUNTED WITH 0'-3" OF SPACE BETWEEN THE BOTTOM OF THE FIXTURE AND THE TOP OF

THE MIRROR UNLESS OTHERWISE NOTED. VERIFY THE EXACT MOUNTING LOCATION FOR ANY PHOTOELECTRIC CELLS WITH THE ARCHITECT PRIOR TO ROUGH-IN.

ALL PHOTOELECTRIC CELLS MUST FACE NORTH. CONTRACTOR SHALL CONFIRM COMPATIBILITY OF ALL LIGHTING CONTROL DEVICES/SWITCHES/DIMMERS WITH LIGHTING FIXTURES AND BALLASTS/DRIVERS PRIOR TO SUBMITTAL.

COORDINATE LOCATION OF LIGHT FIXTURES IN MECHANICAL ROOMS WITH DIVISION 15/23 PLANNED EQUIPMENT LOCATION AND DUCT INSTALLATION. WALL MOUNT LIGHTS OR PROVIDE PENDANT MOUNTING AS REQUIRED TO ILLUMINATE THE

WHERE MULTIPLE OCCUPANCY SENSORS ARE SHOWN IN THE SAME AREA, MOTION DETECTION BY ONE SENSOR SHALL ILLUMINATE ALL LIGHTING IN THE RESPECTIVE AREA.

VERIFY DOOR SWINGS PRIOR TO INSTALLING LIGHT SWITCHES. SWITCHES SHALL BE INSTALLED ON STRIKE SIDE OF DOOR UNLESS OBSTRUCTED BY GLAZING OR GRAPHICS.

LIGHT SWITCHES SHALL BE GANGED UNDER A SINGLE PLATE WHERE GROUPED TOGETHER CONTRACTOR SHALL MAKE FIELD ADJUSTMENTS TO EXIT SIGN LOCATION TO ENSURE THE SIGN IS VISIBLE THROUGHOUT

CORRIDOR SEGMENT. ADJUSTMENTS GREATER THAN 10' FROM LOCATION SHOWN ON PLAN SHALL BE REVIEWED BY

16. CONTRACTOR SHALL ENSURE THAT DOOR SWINGS ARE NOT GOING TO BE IMPEDED BY THE INSTALLATION OF A LIGHT FIXTURE, FIRE ALARM DEVICE, SENSOR, EXIT SIGN, ETC.

REQUIRED

SPECIAL SYSTEMS GENERAL NOTES

1. VERIFY EXACT LOCATION, VOLTAGE, PHASE, AMPERAGE, ETC. OF ALL MECHANICAL EQUIPMENT WITH MECHANICAL

CONTRACTOR PRIOR TO ORDERING ELECTRICAL GEAR. FOR ALL CAMERA LOCATIONS, PROVIDE ONE (1) GREEN JACKETED CAT 6 CABLE IN 3/4" CONDUIT BACK TO ASSOCIATED

FOR ALL WIRELESS ACCESS POINT LOCATIONS, PROVIDE ONE (1) YELLOW JACKETED CAT 6 CABLE IN 3/4" CONDUIT BACK

TO ASSOCIATED DATA CLOSET. PROVIDE AN ADDITIONAL 10%, OR ONE (1), WHICHEVER IS GREATER, OF THE FOLLOWING DEVICES WHICH ARE INCLUDED IN THE PROJECT, AND INSTALL THEM AT THE DIRECTION OF THE ARCHITECT, ENGINEER, OR AHJ DURING THE COURSE OF THE PROJECT. PROVIDE ALL REQUIRED CONDUIT, INTERCONNECTIONS, CONDUCTORS, PROGRAMMING, ETC. AS REQUIRED AT NO ADDITIONAL COST TO THE OWNER: INITIATING DEVICES (PULL STATIONS, SMOKE DETECTORS, THERMAL DETECTORS, ETC.), NOTIFICATION APPLIANCES (STROBES, HORN STROBES, SPEAKER STROBES, SPEAKERS, DUCT

DETECTORS, ETC.), AND MONITORING MODULES. VERIFY REQUIRED QUANTITY OF DUCT DETECTORS WITH DUCTWORK CONFIGURATION AS IT IS ACTUALLY INSTALLED. COORDINATE WITH MECHANICAL CONTRACTOR PRIOR TO ROUGH-IN.

TELECOMMUNICATIONS GENERAL NOTES

WHITE JACKETS.

1. PROVIDE 1" CONDUIT AND TWO (2) CAT 6 CABLES AT EACH DATA OUTLET SHOWN. CABLING SHALL ROUTE TO TELEPHONE BACKBOARD IN IT ROOM. ALL TERMINATIONS SHALL BE BY CONTRACTOR. OWNER SHALL PROVIDE THE WALL MOUNT DATA RACK, ALL ITEMS INCLUDED IN THE DATA RACK, AND ANY NECESSARY

TELEPHONE EQUIPMENT. PLYWOOD FOR BACKBOARDS SHALL BE 0'-1" AC INDOOR GRADE, FIRE RETARDANT, AND PAINTED AS SPECIFIED.

COMMON BOND RACKS, PATCH PANELS, CABLE SHIELDS, PROTECTORS, AND THE BUILDING MAIN ELECTRICAL

GROUNDING CONDUCTORS SHALL BE, AT MINIMUM, #6 AWG INSULATED AND STRANDED COPPER. FASTENERS SHALL BE THE CONTRACTOR IS CAUTIONED TO INSURE NO PAINT PRODUCTS COME IN CONTACT WITH ANY SPECIAL SYSTEM COMPONENTS INCLUDING, BUT NOT LIMITED TO, CABLES, COAX, CONDUCTORS, AND JACKS DURING CONSTRUCTION. IF

ANY PAINT PRODUCT IS PLACED ON ANY COMPONENT, THE COMPONENT SHALL BE REPLACED FROM ITS POINT OF ORIGIN TO THE POINT OF TERMINATION. CAT 6 CABLES FOR DATA OUTLETS SHALL HAVE BLUE JACKETS AND CAT 6 CABLES FOR VOICE OUTLETS SHALL HAVE

IDENTIFICATION OF EQUIPMENT GENERAL NOTES

1. ENGRAVED, LAMINATED ACRYLIC OR MELAMINE LABEL: PUNCHED OR DRILLED FOR SCREW MOUNTING. WHITE LETTERS ON A DARK-GRAY BACKGROUND. MINIMUM LETTER HEIGHT SHALL BE 3/8 INCH. LETTERING AND BACKGROUND COLORS AS INDICATED BELOW: A. POWER CIRCUITS:

NORMAL: WHITE LETTERING ON BLACK BACKGROUND.

EMERGENCY LEGALLY REQUIRED STANDBY OR ESSENTIAL ELECTRICAL SYSTEM PRIOR TO ATS: BLACK LETTERING ON

EMERGENCY OPTIONAL STANDBY: WHITE LETTERING ON PURPLE BACKGROUND

UPS: BLACK LETTERING ON ORANGE BACKGROUND.

FIRE ALARM SYSTEM: BLACK LETTERING ON RED BACKGROUND. LABELING INSTRUCTIONS

INDOOR EQUIPMENT: ENGRAVED, LAMINATED ACRYLIC OR MELAMINE LABEL. UNLESS OTHERWISE INDICATED, PROVIDE A SINGLE LINE OF TEXT WITH 1/2-INCH- HIGH LETTERS ON 1-1/2-INCH- HIGH LABEL; WHERE 2 LINES OF TEXT ARE REQUIRED, USE LABELS 2 INCHES HIGH.

OUTDOOR EQUIPMENT: ENGRAVED, LAMINATED ACRYLIC OR MELAMINE LABEL. EQUIPMENT TO BE LABELED SHALL INCLUDE BUT NOT BE LIMITED TO:

PANELBOARDS, ELECTRICAL CABINETS, AND ENCLOSURES.

EMERGENCY SYSTEM BOXES AND ENCLOSURES.

RECEPTACLES WITH PANEL AND CIRCUIT NUMBERS. DISCONNECT SWITCHES.

POWER TRANSFER EQUIPMENT. (ATS/MTS) FIRE-ALARM CONTROL PANEL AND ANNUNCIATORS

 ALL JUNCTION BOXES. LABEL TO INCLUDE CIRCUIT NUMBERS (PANEL AND NUMBER). ALL LIGHTING SWITCH PLATES SHALL HAVE CIRCUIT NUMBERS ON THE BACK OF THE PLATE. (PANEL AND NUMBER).

DEMOLITION GENERAL NOTES

SHALL REMAIN AND BE LABELED AS A "SPARE."

UNDERGROUND PRIMARY

1. THE LOCATIONS OF EXISTING CIRCUITS AND EQUIPMENT ARE SHOWN IN AN APPROXIMATE WAY ONLY AND HAVE NOT BEEN INDEPENDENTLY VERIFIED BY THE OWNER OR ITS REPRESENTATIVE. THE CONTRACTOR SHALL DETERMINE THE EXACT LOCATION OF ALL EXISTING ELECTRICAL DEVICES, EQUIPMENT, AND WIRING BEFORE COMMENCING WORK AND AGREES TO BE FULLY RESPONSIBLE FOR ANY AND ALL DAMAGES WHICH MIGHT BE CAUSE BY THE CONTRACTOR'S FAILURE TO EXACTLY LOCATE AND PRESERVE ANY AND ALL EXISTING PORTIONS OF THE ELECTRICAL SYSTEMS. THE CONTRACTOR SHALL REMOVE SUCH EXISTING WORK AS CALLED FOR ON THE DRAWINGS OR AS REQUIRED TO CLEAR

THE AREAS OF NEW CONSTRUCTION. ALL EQUIPMENT REMOVED THAT IS NOT BEING REUSED SHALL REMAIN THE PROPERTY OF THE OWNER OR SHALL BE DISPOSED OF AS REQUIRED. PRIOR TO START OF CONSTRUCTION, CONTRACTOR SHALL WALK AREAS TO BE RENOVATED

WITH OWNER TO IDENTIFY AND DOCUMENT ITEMS TO BE SALVAGED FOR OWNER'S USE. 4. EXCEPT AS OTHERWISE NOTED, ALL EXISTING ELECTRICAL WORK WHICH WILL NOT BE RENDERED OBSOLETE AND WHICH MAY BE DISTURBED DUE TO ANY CHANGES REQUIRED UNDER THIS CONTRACT, SHALL BE RESTORED TO ITS ORIGINAL OPERATING CONDITION. OTHER ELECTRICAL WORK OR MATERIAL RENDERED OBSOLETE SHALL BE ABANDONED WHERE CONCEALED AND REMOVED WHERE EXPOSED. OLD, UNUSED WIRING AND DEVICES SHALL BE REMOVED FROM THE

ABANDONED (CONCEALED) CONDUITS. OUTLETS SHALL BE PROVIDED WITH BLANK COVERS. ANY CONDUITS STUBBED OUT OF MASONRY SURFACE SHALL BE CUT INTO SURFACE AND PATCHED. WHERE EXISTING ELECTRICAL WORK INTERFERES WITH NEW WORK AND WHERE SUCH INSTALLATIONS ARE TO REMAIN IN USE, THE INSTALLATIONS SHALL BE DISCONTINUED AND RELOCATED AND/OR RECONNECTED TO COORDINATE WITH THE

WORK INDICATED ON THE CONTRACT DRAWINGS AS SPECIFIED. WHERE EXISTING RACEWAYS THAT ARE NOT TO BE REUSED INTERFERE WITH NEW WORK, THESE RACEWAYS SHALL BE

REMOVED BACK TO THE NEAREST JUNCTION BOX OR PULL BOX AND THE OPENINGS BLANKED. CONTRACTOR SHALL MAINTAIN CONTINUITY OF BRANCH CIRCUITS SERVING MULTIPLE ITEMS OF WHICH ONE OR MORE ARE BEING DEMOLISHED. CONDUCTORS AND CONDUITS FOR THOSE ITEMS BEING DEMOLISHED SHALL BE REMOVED AS

FAR AS PRACTICABLE 8. IT SHALL BE THE CONTRACTOR'S RESPONSIBILITY TO REMOVE ALL EXISTING ELECTRICAL DEVICES/EQUIPMENT AND DATA WIRING NOT REUSED OR NOT NECESSARY FOR THE COMPLETION OF THIS PROJECT.

DISCONNECT AND REMOVE ABANDONED PANELBOARDS, DISTRIBUTION EQUIPMENT, LIGHTING, AND DEVICES. REMOVE ASSOCIATED CONDUIT TO NEAREST ABOVE CEILING JUNCTION BOX. 10. IF ANY BRANCH CIRCUIT WIRING FEEDING EQUIPMENT TO REMAIN IN PLACE FOR REUSE IS DAMAGED DURING

CONSTRUCTION, THE CONTRACTOR SHALL REPLACE THE NEW BRANCH CIRCUIT WIRING OF THE SAME SIZE AND TYPE AS THAT OF THE EXISTING AT NO COST TO THE OWNER. 11. EXISTING DEVICES ARE SHOWN IN GRAY. CONDUIT AND WIRING ARE NOT GENERALLY SHOWN AND SHALL BE THE

WHICH INDICATES WHERE "SPARE" BREAKERS ARE LOCATED. ANY EXISTING BREAKERS THAT ARE NOT FEEDING DEVICES

RESPONSIBILITY OF THE CONTRACTOR. ADDITIONAL DEMOLITION WORK AND CLARIFICATION OF INDICATED WORK WILL BE 12. COORDINATE THE REMOVAL AND REINSTALLATION (OR PROTECTION IN PLACE) OF EXISTING ELECTRICAL EQUIPMENT AND DEVICES WITH THE WORK OF OTHER TRADES TO REPLACE OR REFINISH EXISTING WALLS AND CEILINGS.

13. WHERE EXISTING CIRCUITS ARE BEING REMOVED IN EXISTING PANELS, PROVIDE A NEW, NEATLY TYPED DIRECTORY

ABBREVIATIONS

CATEGORY

Α	AMPERE(S)	CATV	CABLE TELEVISION	EF	EXHAUST FAN	FOC	FIBER OPTIC CABLE	MCB	MAIN CIRCUIT BREAKER	NO	NORMALLY OPEN	SF	SUPPLY FAN	UGS	UNDERGROUND SECONDARY
AC	ABOVE COUNTER (6" ABOVE BACKSPLASH)	СВ	CIRCUIT BREAKER	EGC	EQUIPMENT GROUNDING CONDUCTOR	G, GND	GROUND	MCM/KCMIL	L 1,000 CIRCULAR MILS	NU	WEATHERPROOF IN-USE COVER	S/N	SOLID NEUTRAL	UH	UNIT HEATER
AF	AMPERE(S) FUSED	CKT	CIRCUIT	EMER.	EMERGENCY	GEC	GROUNDING ELECTRODE CONDUCTOR	MECH.	MECHANICAL	OH	OVERHEAD	SPD	SURGE PROTECTIVE DEVICE	UL	UNDERWRITER'S LABORATORY, INC.
AFCI	ARC FAULT CIRCUIT INTERRUPTER	CLG	CLG	EMT	ELECTRICAL METALLIC TUBING	GFCI	GROUND FAULT CIRCUIT INTERRUPTER	MH	MANHOLE	OHE	OVERHEAD ELECTRICAL	STD	STANDARD	UON	UNLESS OTHERWISE NOTED
AFF	ABOVE FINISHED FLOOR	CORR	CORRIDOR	EQ	EQUAL	GRS	GALVANIZED RIGID STEEL	MLO	MAIN LUGS ONLY	OSP	OUTSIDE PLANT	TEL	TELEPHONE	V	VOLTS
AFG	ABOVE FINISHED GRADE	CT	CURRENT TRANSFORMER	EQUIP.	EQUIPMENT	HH	HANDHOLE	MOCP	MAXIMUM OVERCURRENT PROTECTION	UPP	UTILITY POWER POLE	TELECOM	TELECOMMUNICATIONS	VAC	VOLTS ALTERNATING CURRENT
AIC	ABOVE FINISHED GRADE	CTRL	CONTROLLER	EWC	ELECTRIC WATER COOLER	HP	HORSEPOWER	MTD	MOUNTED	PB	PULL BOX	TGB	TELECOMMUNICATIONS GROUND BUS	VDC	VOLTS DIRECT CURRENT
AT	AMP SYMMETRICAL INTERRUPTING CAPACITY RMS	D	TO BE DEMOLISHED	EWH	ELECTRICA WATER HEATER	KAIC	1,000 AMP SYMMETRICAL INTERRUPTING CAPACITY RMS	MTG	MOUNTING	PH	PHASE	TMGB	TELECOMMUNICATIONS MAIN GROUND BUS	VFD	VARIABLE FREQUENCY DRIVE
AWG	AMERICAN WIRE GAUGE	DISC.	DISCONNECT	EXIST.	EXISTING	KWH	1,000 WATT HOURS	NC	NORMALLY CLOSED	PNL	PANEL	TTB	TELECOM TERMINAL BOARD	WH	WATER HEATER
BG	BELOW GRADE	DIST.	DISTRIBUTION	FACP	FIRE ALARM CONTROL PANEL	KVA	1,000 VOLT AMPERES	NEC	NATIONAL ELECTRICAL CODE	PV	PHOTOVOLTAIC	TV	TELEVISION	WP	WEATHERPROOF
BLDG	BUILDING	DWG	DRAWING	FACPRA	FIRE ALARM CONTROL PANEL REMOTE ANNUNCIATOR	LAN	LOCAL AREA NETWORK	NEU	NEUTRAL	PVC	POLYVINYL CHLORIDE	TVSS	TRANSIENT VOLTAGE SURGE SUPPRESSION	XFMR	TRANSFORMER
BKR	BREAKER	Е	EXISTING TO REMAIN	FC	FOOTCANDLE	LC	LIGHTING CONTACTOR	NF	NON-FUSED	QTY	QUANTITY	TYP.	TYPICAL		
С	CONDUIT	EC	EMPTY CONDUIT	FCU	FAN COIL UNIT	LTG	LIGHTING	NIC	NOT IN CONTRACT	RCPT	RECEPTACLE	UG	UNDERGROUND		

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CONSTRUCTION SET 3/15/24

BAC

LDB

PROJECT NUMBER: 2023.04

ELECTRICAL

COVER

SHEET


PROFESSIONAL ENGINEER

ALL SYMBOLS, ABBREVIATIONS, AND NOTES ABOVE ARE TYPICAL AND ARE NOT NECESSARILY USED IN THESE CONSTRUCTION DOCUMENTS

MINIMUM CIRCUIT AMPACITY

NIGHT LIGHT



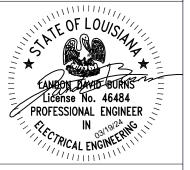

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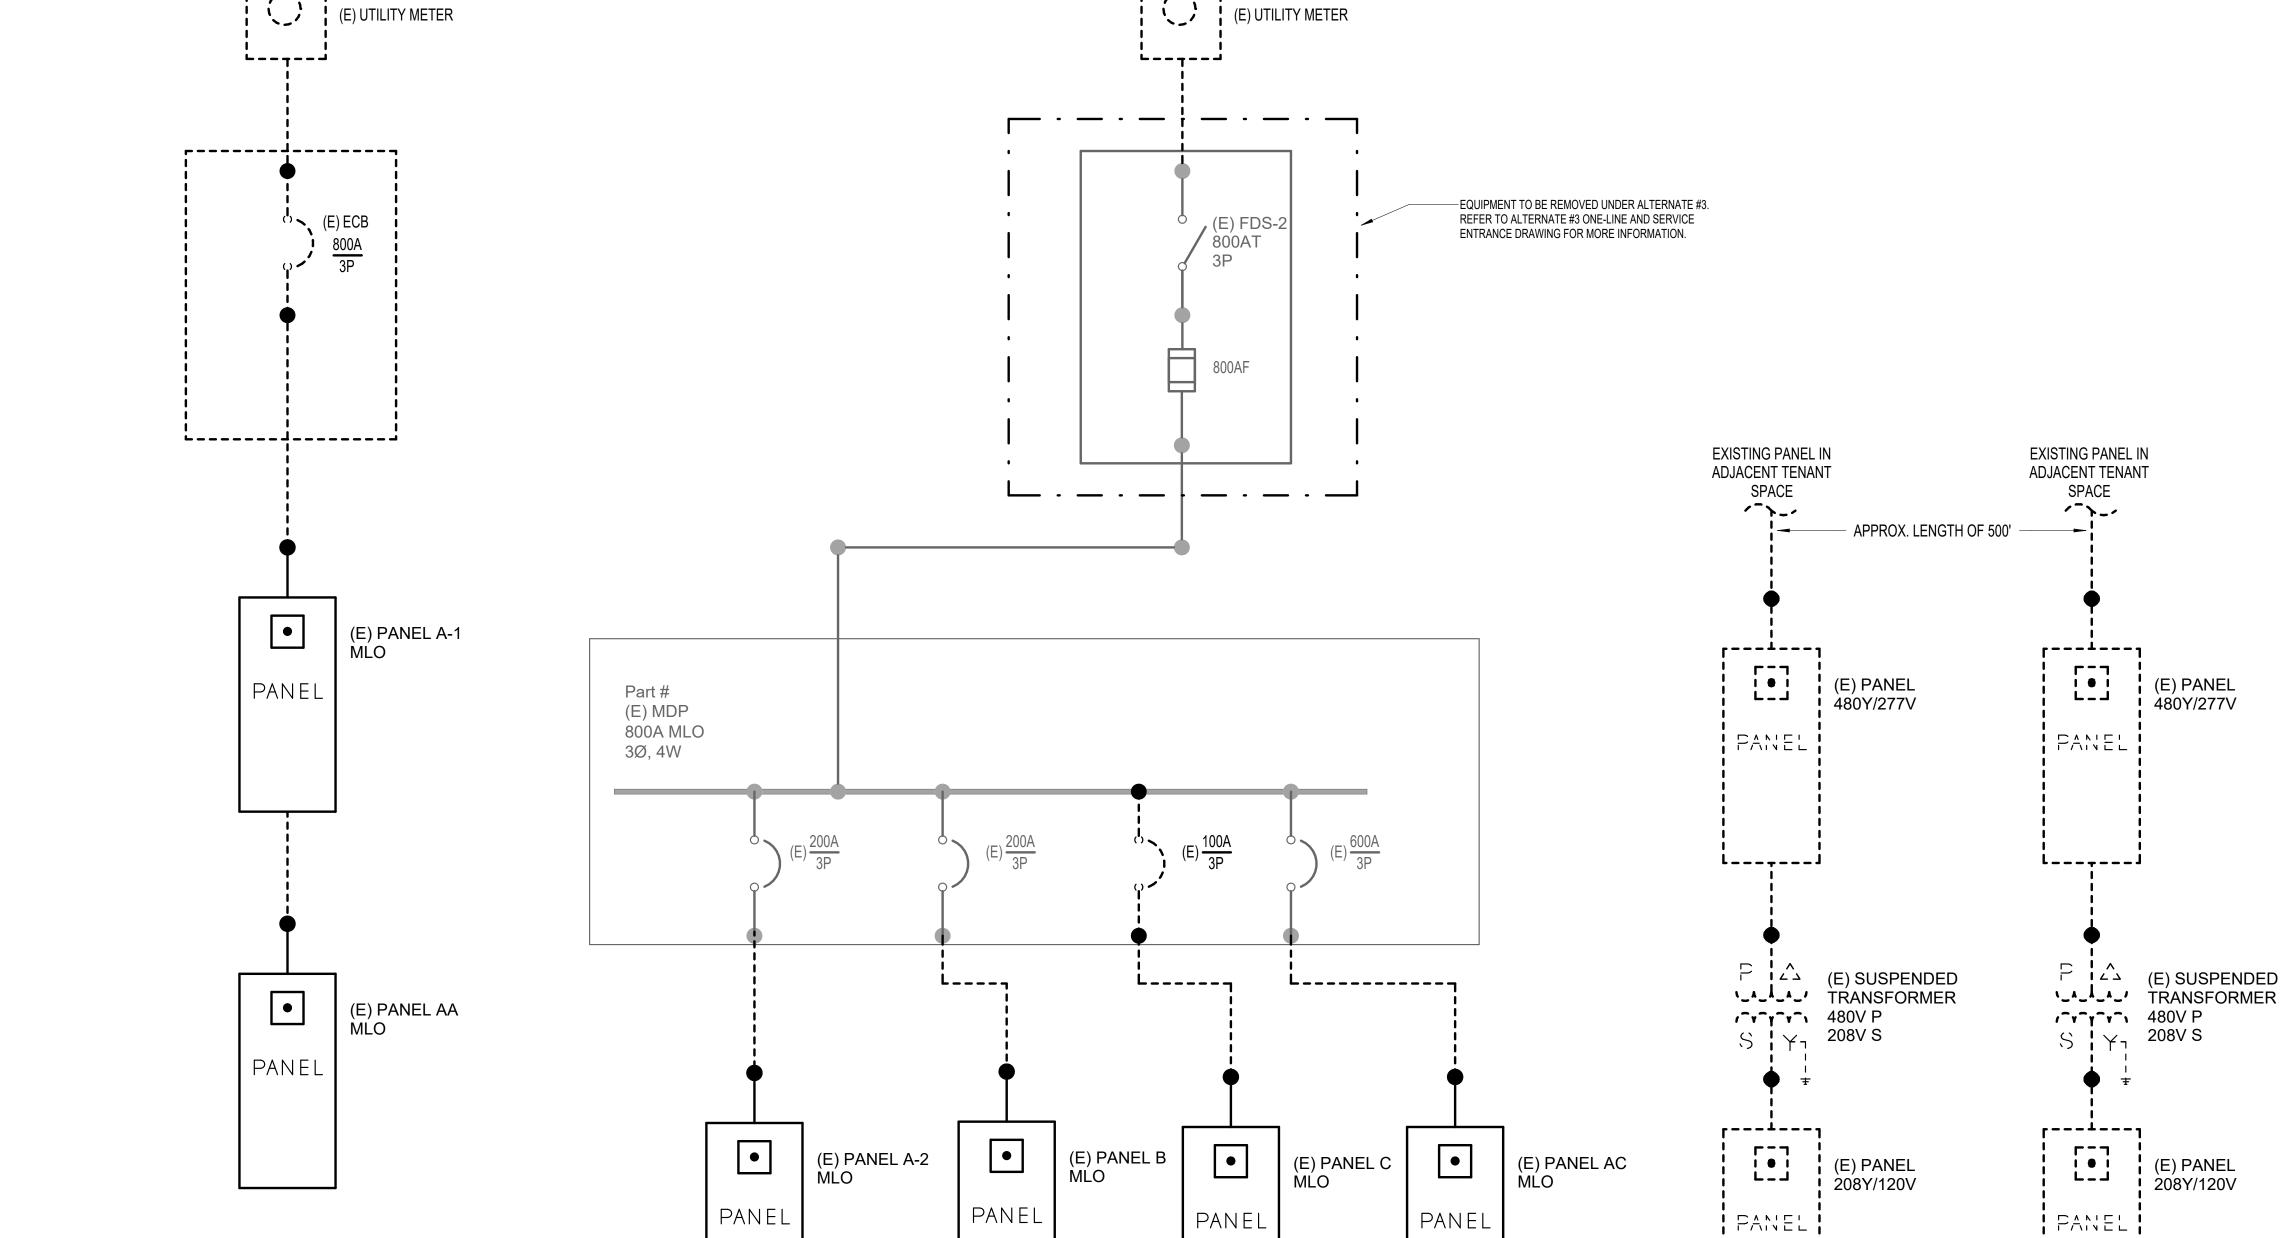
> **DEMOLITION** ONE-LINE



L----J







EXISTING SERVICE #2

(E) INCOMING

SERVICE

208Y/120V

3Ø, 4W

EXISTING SERVICE #1

(E) INCOMING

SERVICE


208Y/120V

3Ø, 4W

``----*`*`

F--4---

DEMOLITION ONE-LINE N.T.S.

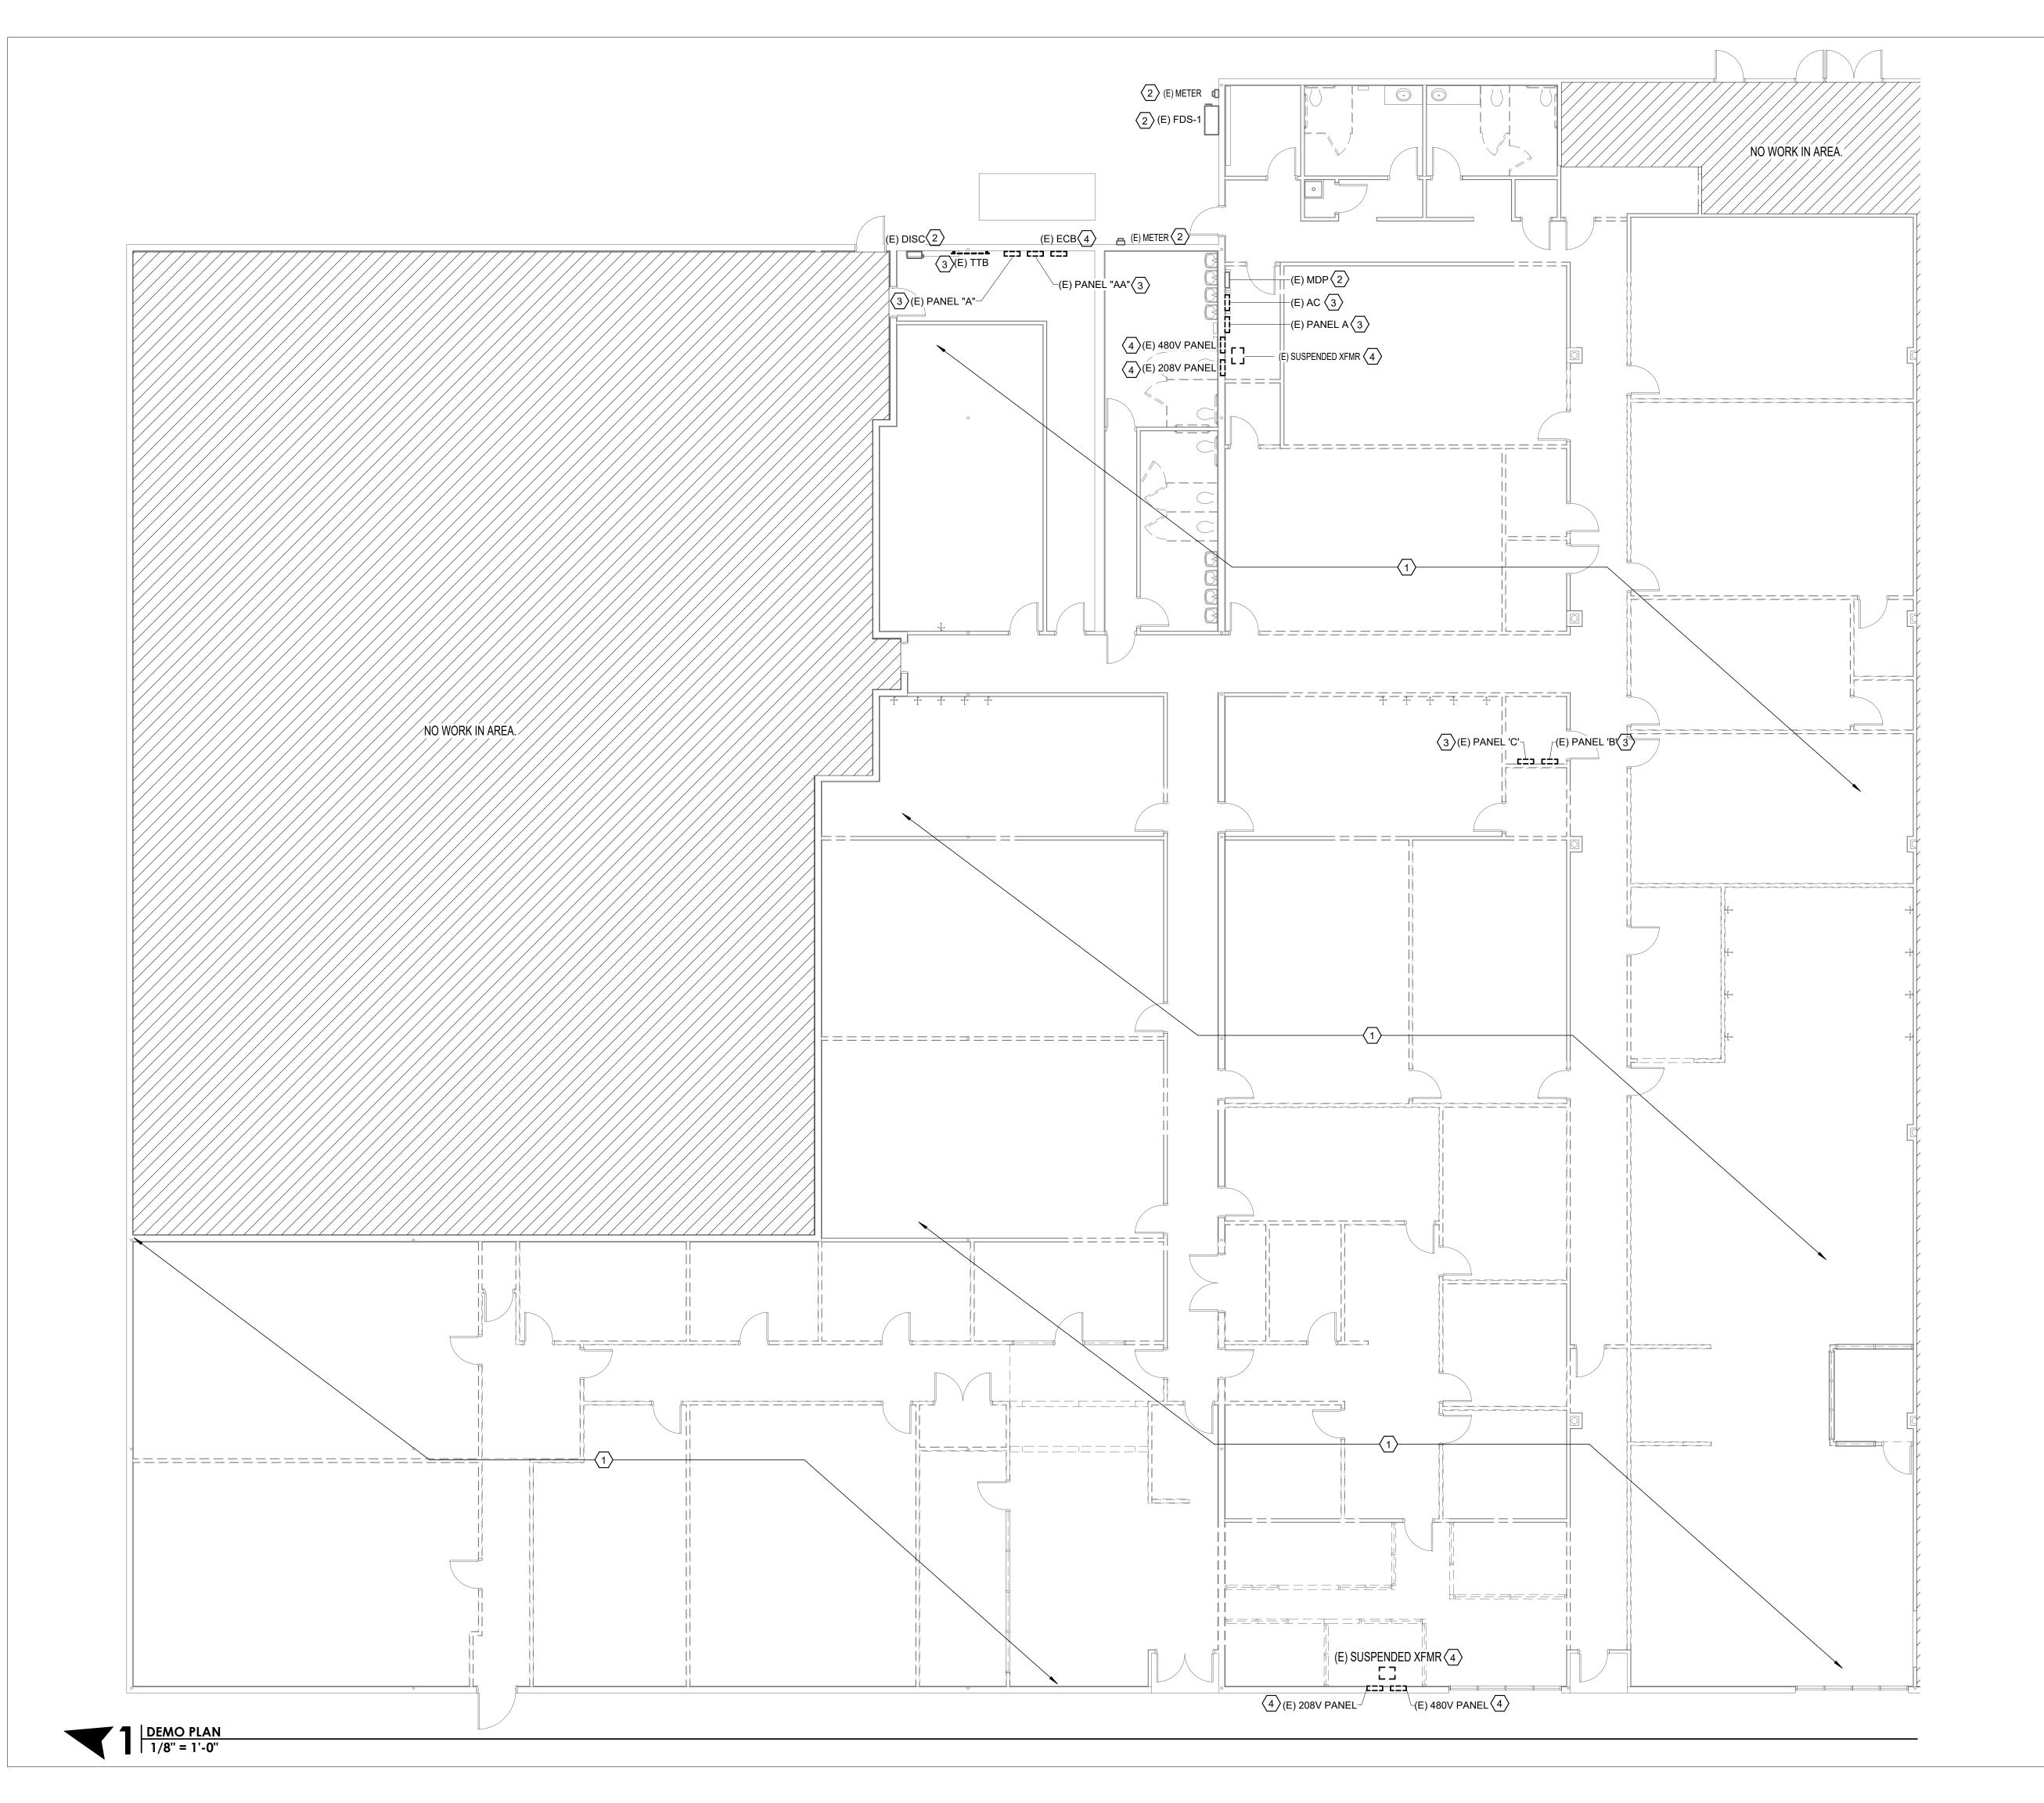


DEMOLITION GENERAL NOTES:

- CONTRACTOR SHALL DEMOLISH ALL FIXTURES, DEVICES, AND EQUIPMENT IN AREA UNLESS OTHERWISE NOTED. CONTRACTOR SHALL REMOVE CABLING AND RACEWAY BACK TO SOURCE.
- (2) EXISTING ELECTRICAL EQUIPMENT TO REMAIN.
- 3 EXISTING ELECTRICAL EQUIPMENT TO BE RELOCATED. SEE POWER PLAN FOR NEW LOCATION.
- DEMOLISH EXISTING ELECTRICAL EQUIPMENT AND ASSOCIATED CABLING AND RACEWAY.

1340 Wesr Tunnel Bly Suite 420 Houma, LA 70360 985.262.3846 www.archestrate.com



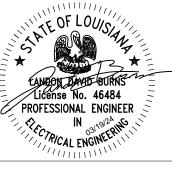

SOUTH CENTRAL LOUISIANA HUMAN SERVICES AUTHORITY

NO. SUBMISSION DATE

1 CONSTRUCTION SET 3/15/24

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PROJECT NUMBER: 2023.04


SHEET TITLE

ELECTRICA

ELECTRICAL DEMO PLAN

SHEET NO



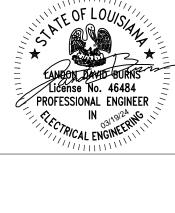

SIAN 0364 HOUN BARROW

805

NO. SUBMISSION DATE CONSTRUCTION SET 3/15/24

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SHEET TITLE BASE BID

ONE-LINE



4-WIRE FEEDER SCHEDULE - COPPER

THHN/THWN-2/XHHW CONDUCTORS

4#12, 1#12 GND

4#10, 1#10 GND

1 4#8, 1#10 GND

4#8, 1#10 GND

4#6, 1#10 GND

4#4, 1#8 GND

4#3, 1#8 GND

4#1, 1#6 GND

4#1/0, 1#8 GND

4#2/0, 1#6 GND

4#3/0, 1#6 GND

4#4/0, 1#1/0 GND

4#250 KCMIL, 1#4 GND

4#350 KCMIL, 1#3 GND

4#400 KCMIL, 1#3 GND

4#250KCMIL, 1#2 GND

2 4#350 KCMIL, 1#1 GND

2 4#400 KCMIL, 1#1/0 GND

3 4#300 KCMIL, 1#1/0 GND

3 4#400 KCMIL, 1#2/0 GND

4 4#350 KCMIL, 1#3/0 GND

5 4#400 KCMIL, 1#4/0 GND

6 4#400 KCMIL, 1#250 KCMIL GND

8 4#500 KCMIL, 1#400 KCMIL GND

11 4#500 KCMIL, 1#500 KCMIL GND

2. ELECTRICAL CONTRACTOR TO VERIFY SIZE REQUIRED IF WIRE TYPES

OTHER THAN THOSE LISTED ABOVE ARE USED.

SUBSCRIPTS:
| "VD" - INDICATES UPSIZED FOR VOLTAGE DROP

"N" - INDICATES NO NEUTRAL REQUIRED

"G" - INDICATES NO GROUND REQUIRED

1. ALL FEEDER SIZES LISTED MAY NOT BE SHOWN IN POWER RISER DIAGRAM.

REFER TO THE 2020 EDITION OF THE NEC FOR CONDUIT TYPES REQUIRED

GROUND SIZES INDICATED IN SCHEDULE ARE PER NEC 250.122. REFER TO

"GEC" - INDICATES GROUND WIRE SHALL BE PER NEC 250.66. REFER TO GROUNDING ELECTRODE CONDUCTOR GEC COLUMN FOR SIZING INFORMATION. GEC

NEC 250.66 FOR GROUND SIZE AT SEPARATELY DERIVED SYSTEMS.

900 3 4#350 KCMIL, 1#2/0 GND

4#3/0, 1#3 GND

CONDUIT SIZE

3/4"

3/4"

3/4"

1"

1-1/2"

2"

2"

3"

2"

2"

3"

3"

3/4" #8

1-1/4" #8

1-1/4" #8

2" #4

2-1/2" #2

2-1/2" #2

3" #2

#1/0

#1/0

#2/0

#2/0

#2/0

#3/0

#3/0

#3/0

#3/0

#3/0

#3/0

(XXX)

STD. FUSE OR # OF BKR TRIP SIZE SETS

30

40

70 80

90 100

200


350

400

GROUNDING ELECTRODE

CONDUCTOR

(MINIMUM) (REFER TO SUBSCRIPT GEC)

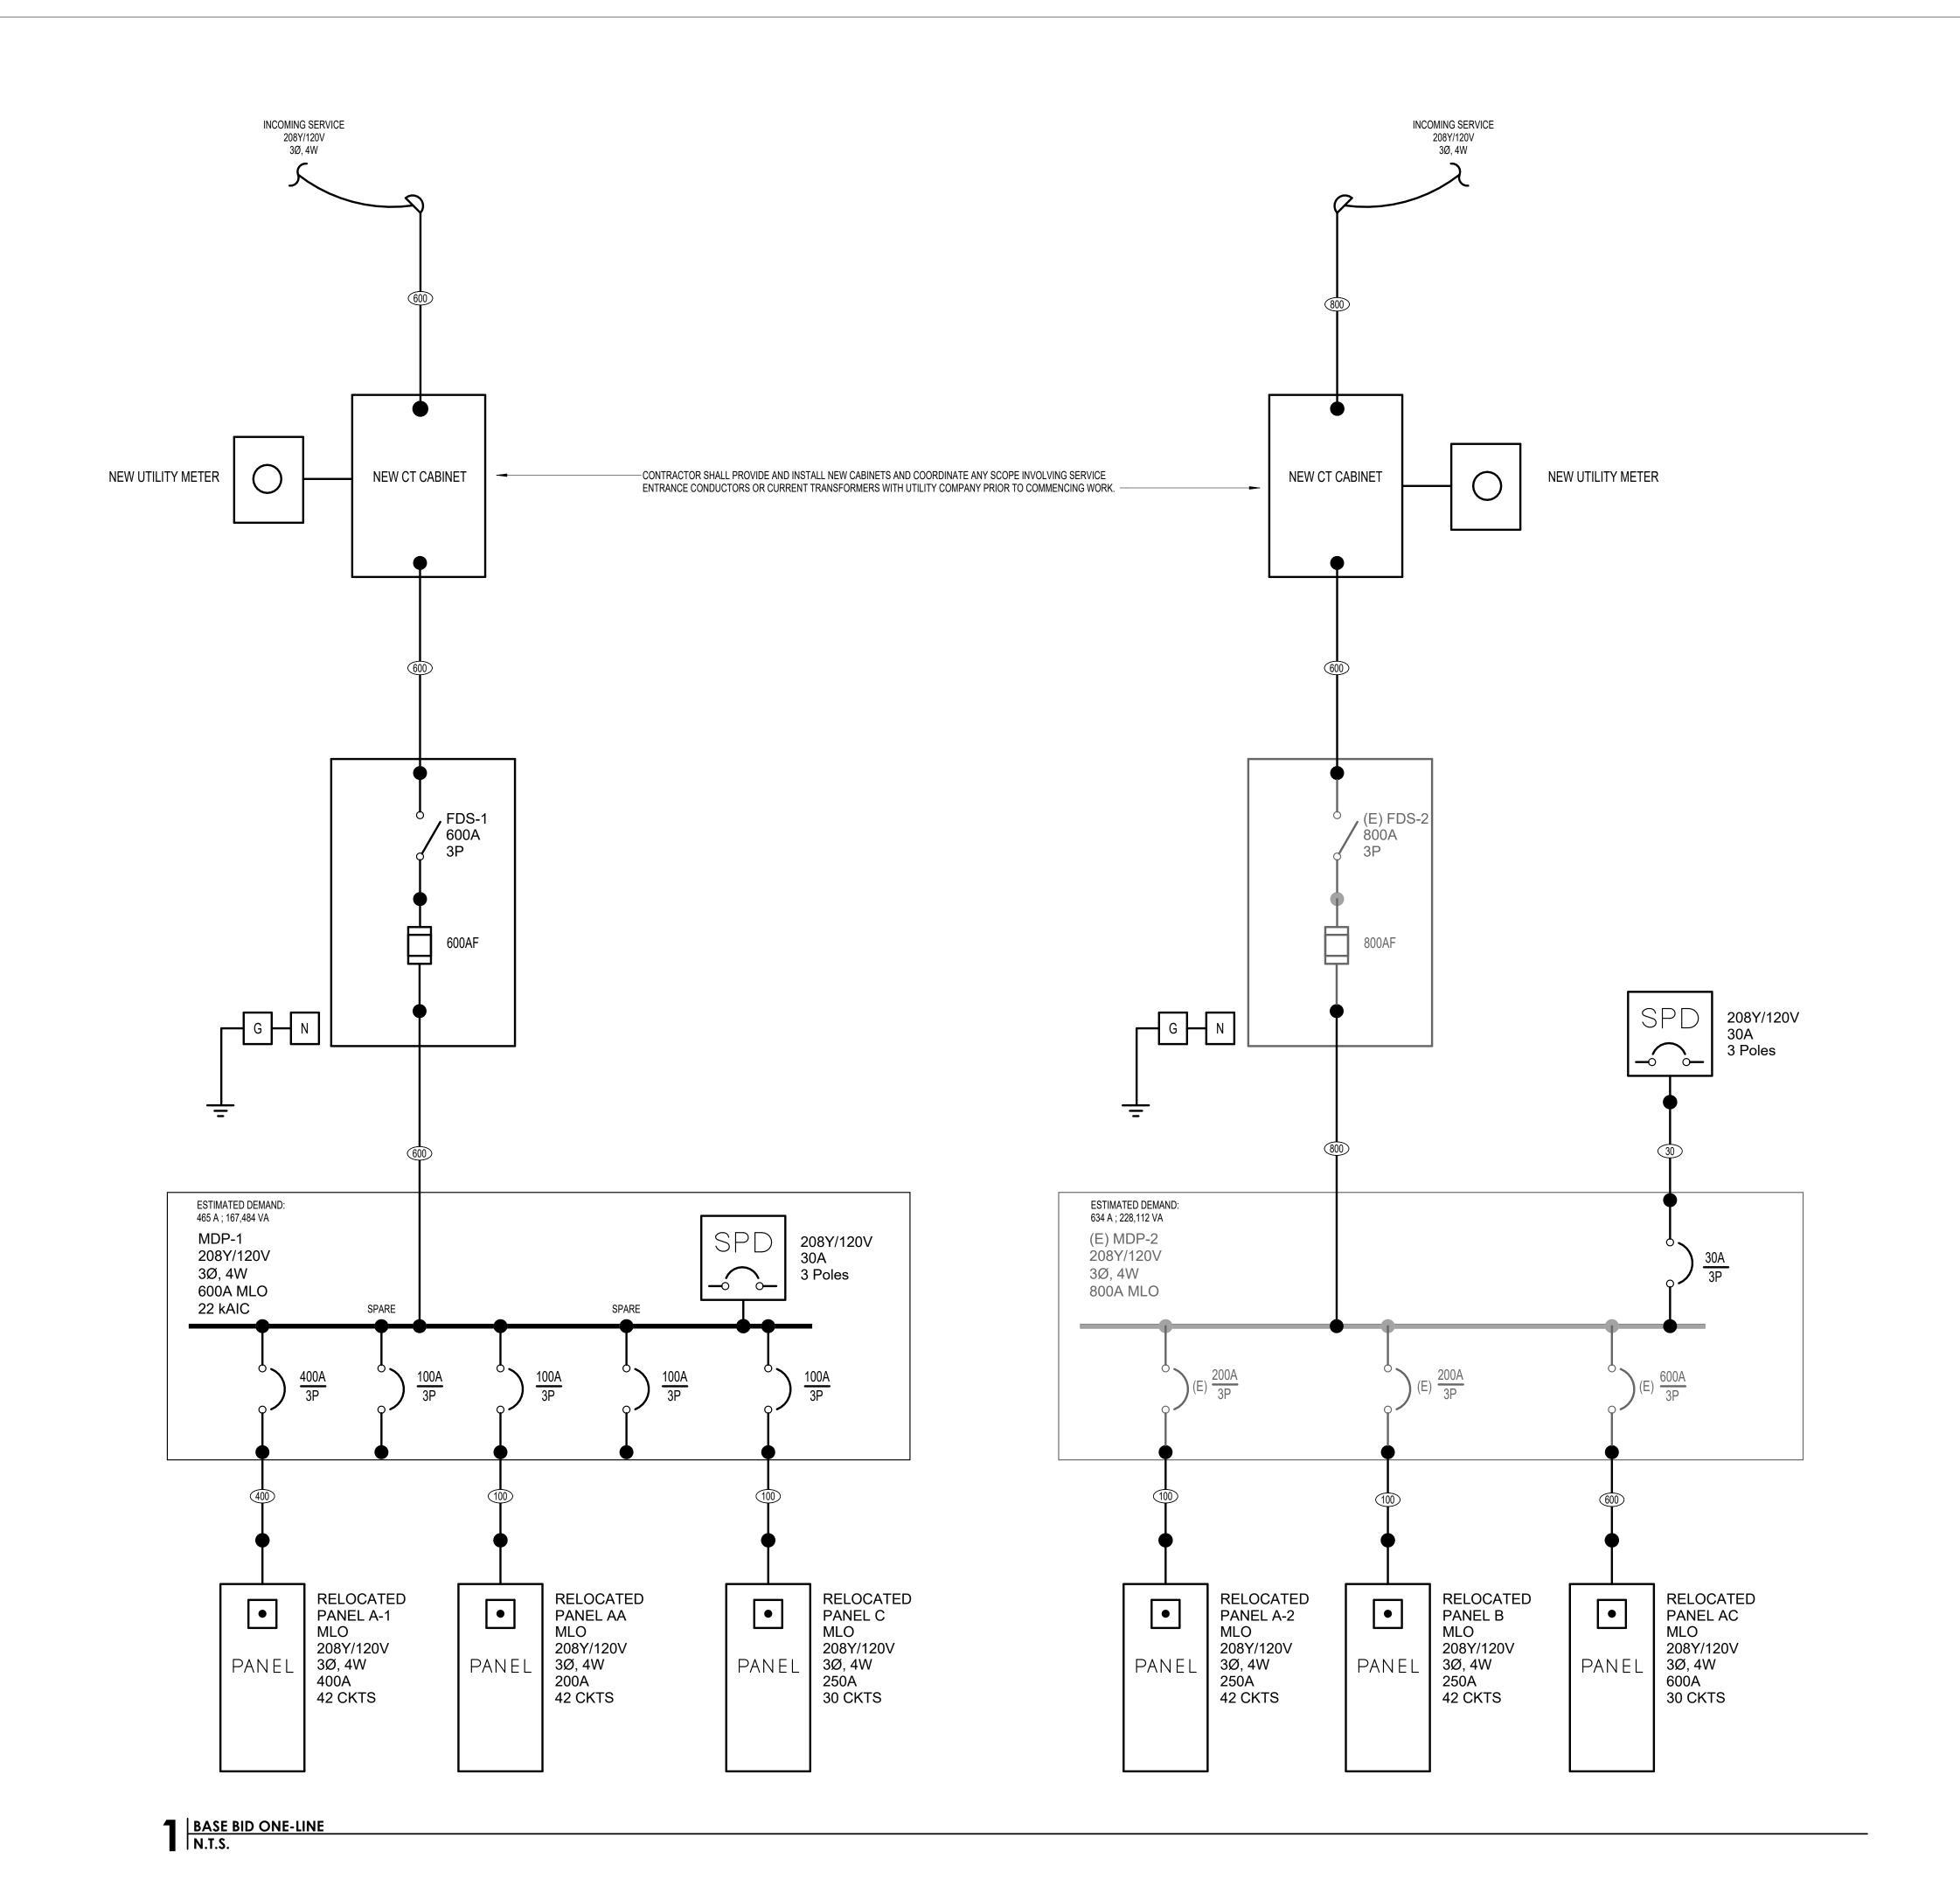


HOUN BARROW 805

NO. SUBMISSION DATE CONSTRUCTION SET 3/15/24

BAC DRAWN BY: LDB CHECKED BY: PROJECT NUMBER: 2023.04 SHEET TITLE

> ALTERNATE #3 ONE-LINE



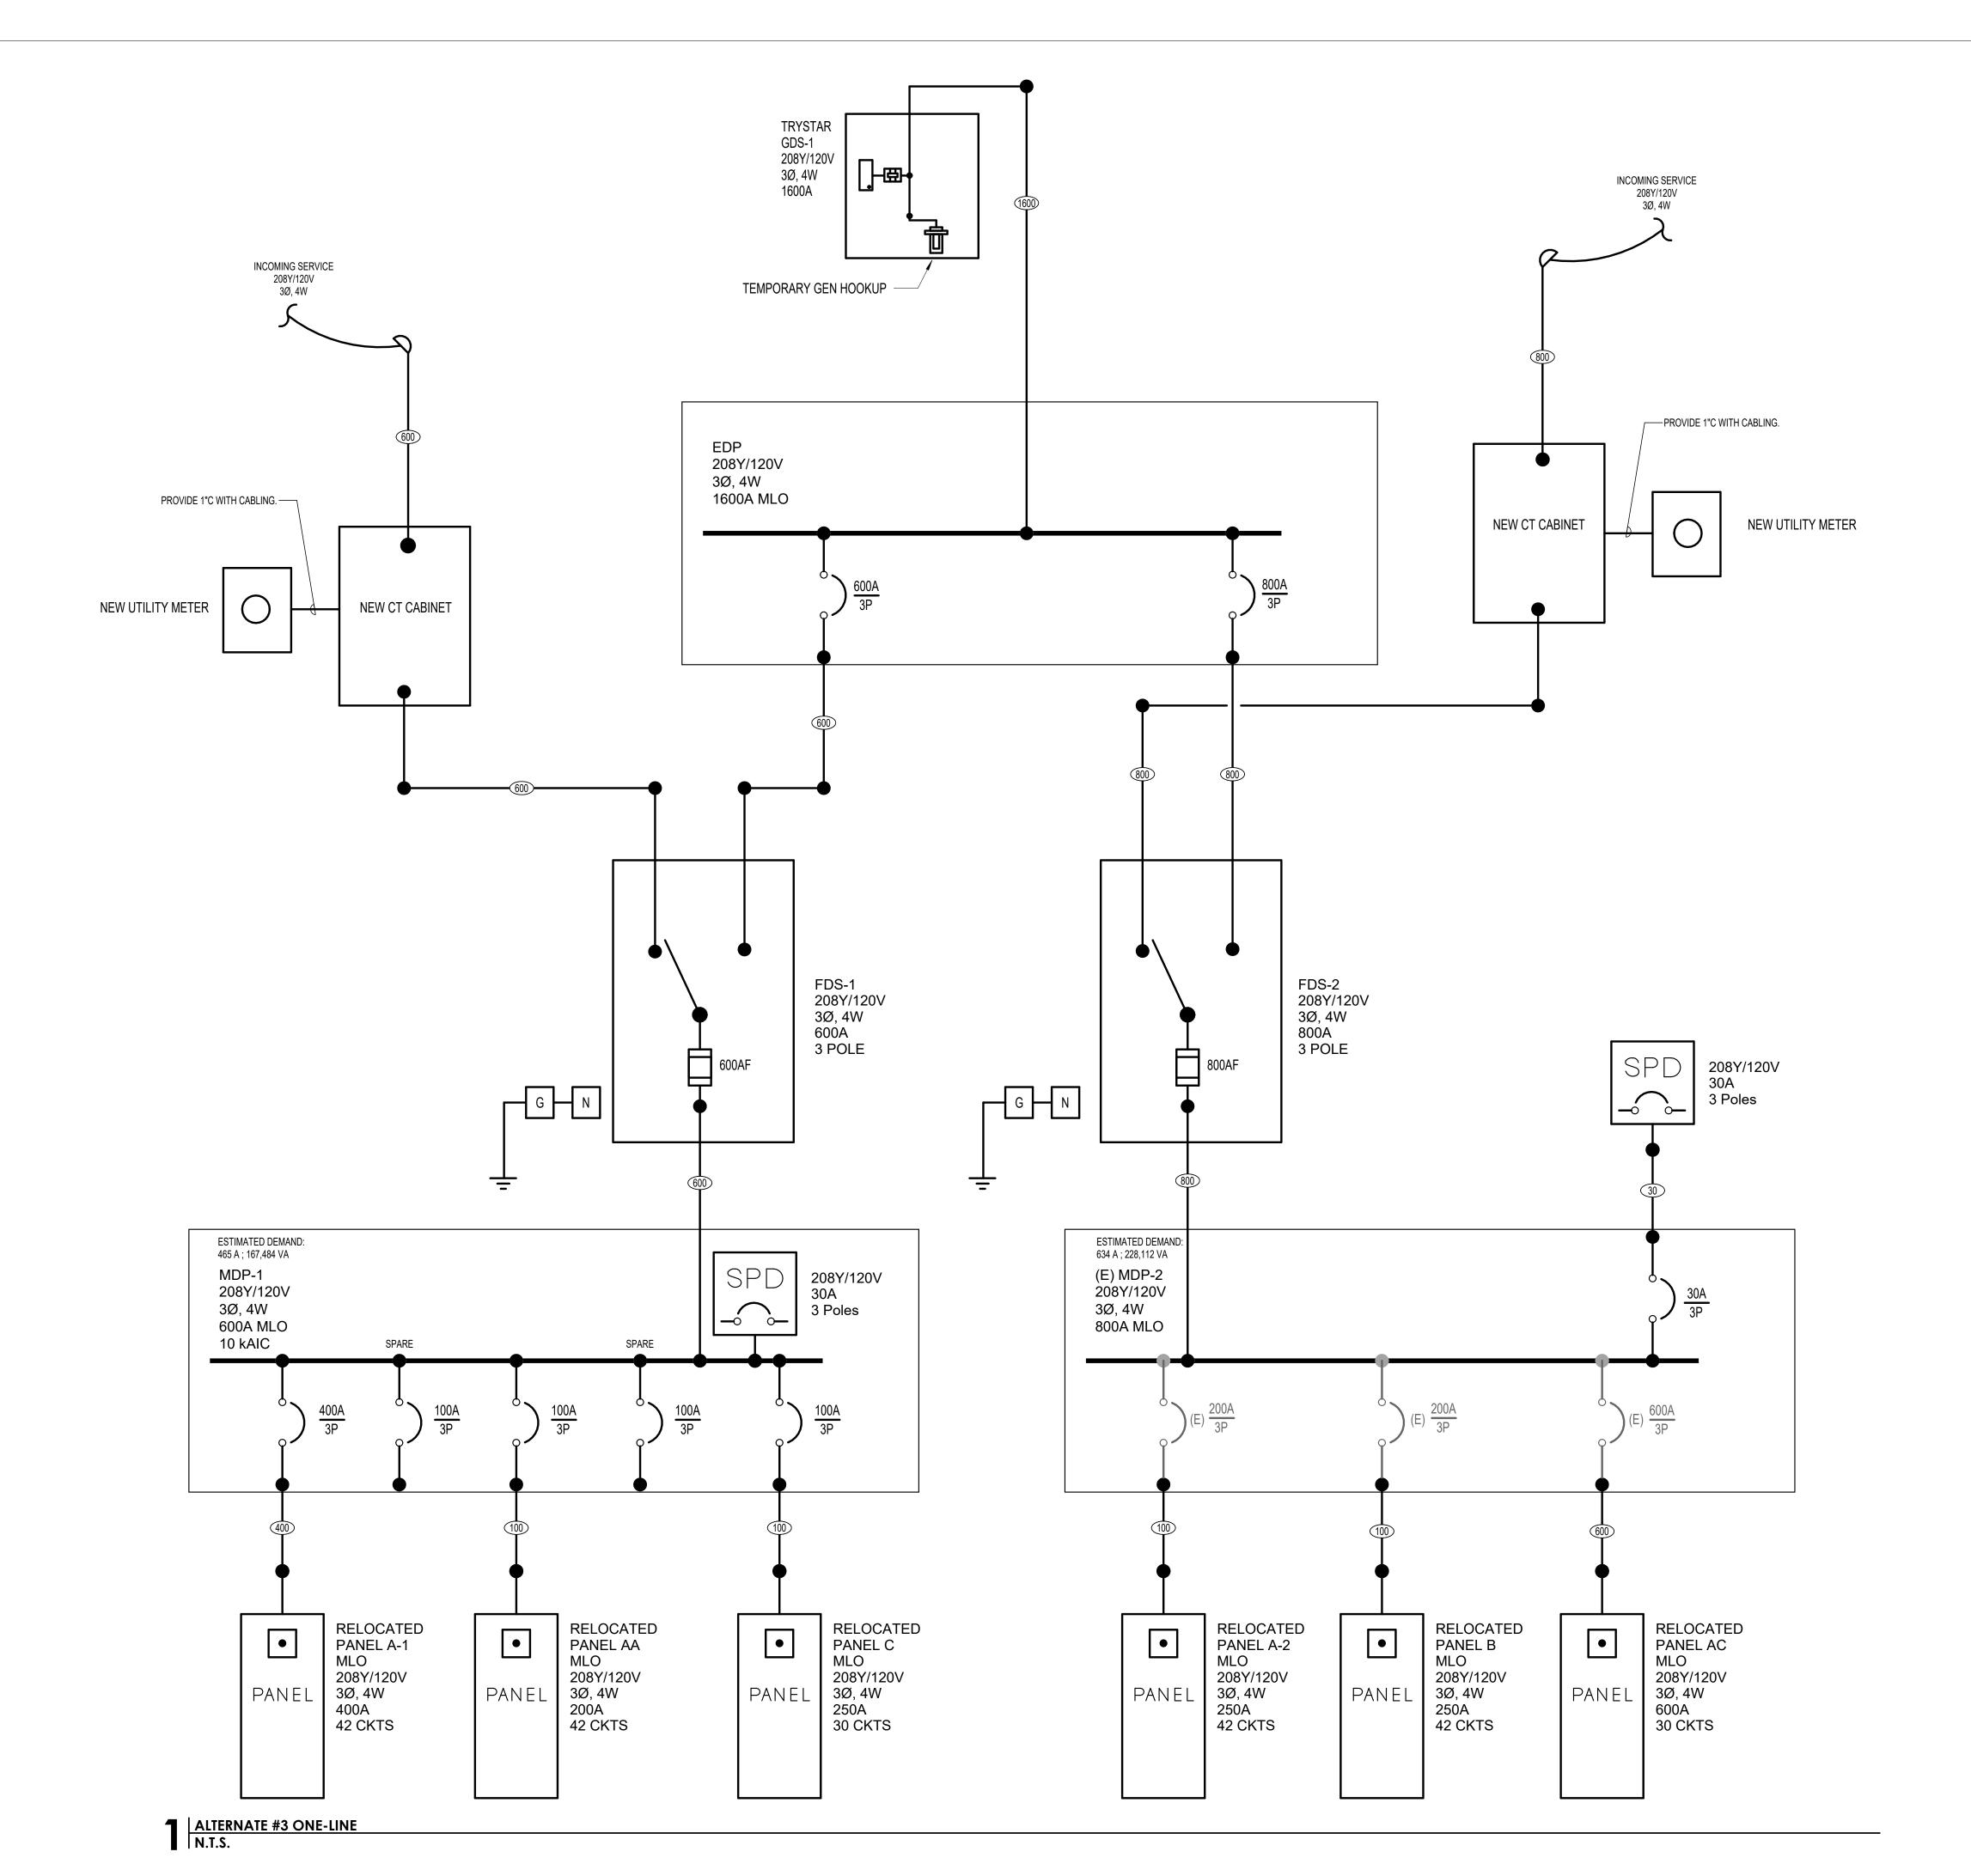

STD. FUSE OR BKR TRIP SIZE	# OF SETS	THHN/THWN-2/XHHW CONDUCTORS	CONDUIT SIZE (MINIMUM)	GROUNDING ELECTF CONDUCTOR (REFER TO SUBSCRIP
20	1	4#12, 1#12 GND	3/4"	#8
30	1	4#10, 1#10 GND	3/4"	#8
40	1	4#8, 1#10 GND	3/4"	#8
50	1	4#8, 1#10 GND	3/4"	#8
60	1	4#6, 1#10 GND	1"	#8
70 80	1	4#4, 1#8 GND	1-1/4"	#8
90 100	1	4#3, 1#8 GND	1-1/4"	#8
125	1	4#1, 1#6 GND	1-1/2"	#6
150	1	4#1/0, 1#8 GND	2"	#6
175	1	4#2/0, 1#6 GND	2"	#4
200	1	4#3/0, 1#6 GND	2"	#4
225	1	4#4/0, 1#1/0 GND	2-1/2"	#2
250	1	4#250 KCMIL, 1#4 GND	2-1/2"	#2
300	1	4#350 KCMIL, 1#3 GND	3"	#2
350	1	4#400 KCMIL, 1#3 GND	3"	#1/0
400	2	4#3/0, 1#3 GND	2"	#2
500	2	4#250KCMIL, 1#2 GND	2"	#1/0
600	2	4#350 KCMIL, 1#1 GND	3"	#2/0
700	2	4#400 KCMIL, 1#1/0 GND	3"	#2/0
800	3	4#300 KCMIL, 1#1/0 GND	3"	#2/0
900	3	4#350 KCMIL, 1#2/0 GND	3"	#2/0
1000	3	4#400 KCMIL, 1#2/0 GND	3"	#3/0
1200	4	4#350 KCMIL, 1#3/0 GND	3"	#3/0
1600	5	4#400 KCMIL, 1#4/0 GND	3"	#3/0
2000	6	4#400 KCMIL, 1#250 KCMIL GND	3"	#3/0
3000	8	4#500 KCMIL, 1#400 KCMIL GND	3"	#3/0
4000	11	4#500 KCMIL, 1#500 KCMIL GND	3"	#3/0

2. ELECTRICAL CONTRACTOR TO VERIFY SIZE REQUIRED IF WIRE TYPES OTHER THAN THOSE LISTED ABOVE ARE USED. REFER TO THE 2020 EDITION OF THE NEC FOR CONDUIT TYPES REQUIRED

PER THEIR TABLES.


GROUND SIZES INDICATED IN SCHEDULE ARE PER NEC 250.122. REFER TO NEC 250.66 FOR GROUND SIZE AT SEPARATELY DERIVED SYSTEMS.

SUBSCRIPTS:
"VD" - INDICATES UPSIZED FOR VOLTAGE DROP

"N" - INDICATES NO NEUTRAL REQUIRED "G" - INDICATES NO GROUND REQUIRED

"GEC" - INDICATES GROUND WIRE SHALL BE PER NEC 250.66. REFER TO GROUNDING ELECTRODE CONDUCTOR GEC COLUMN FOR SIZING INFORMATION. GEC

XXX

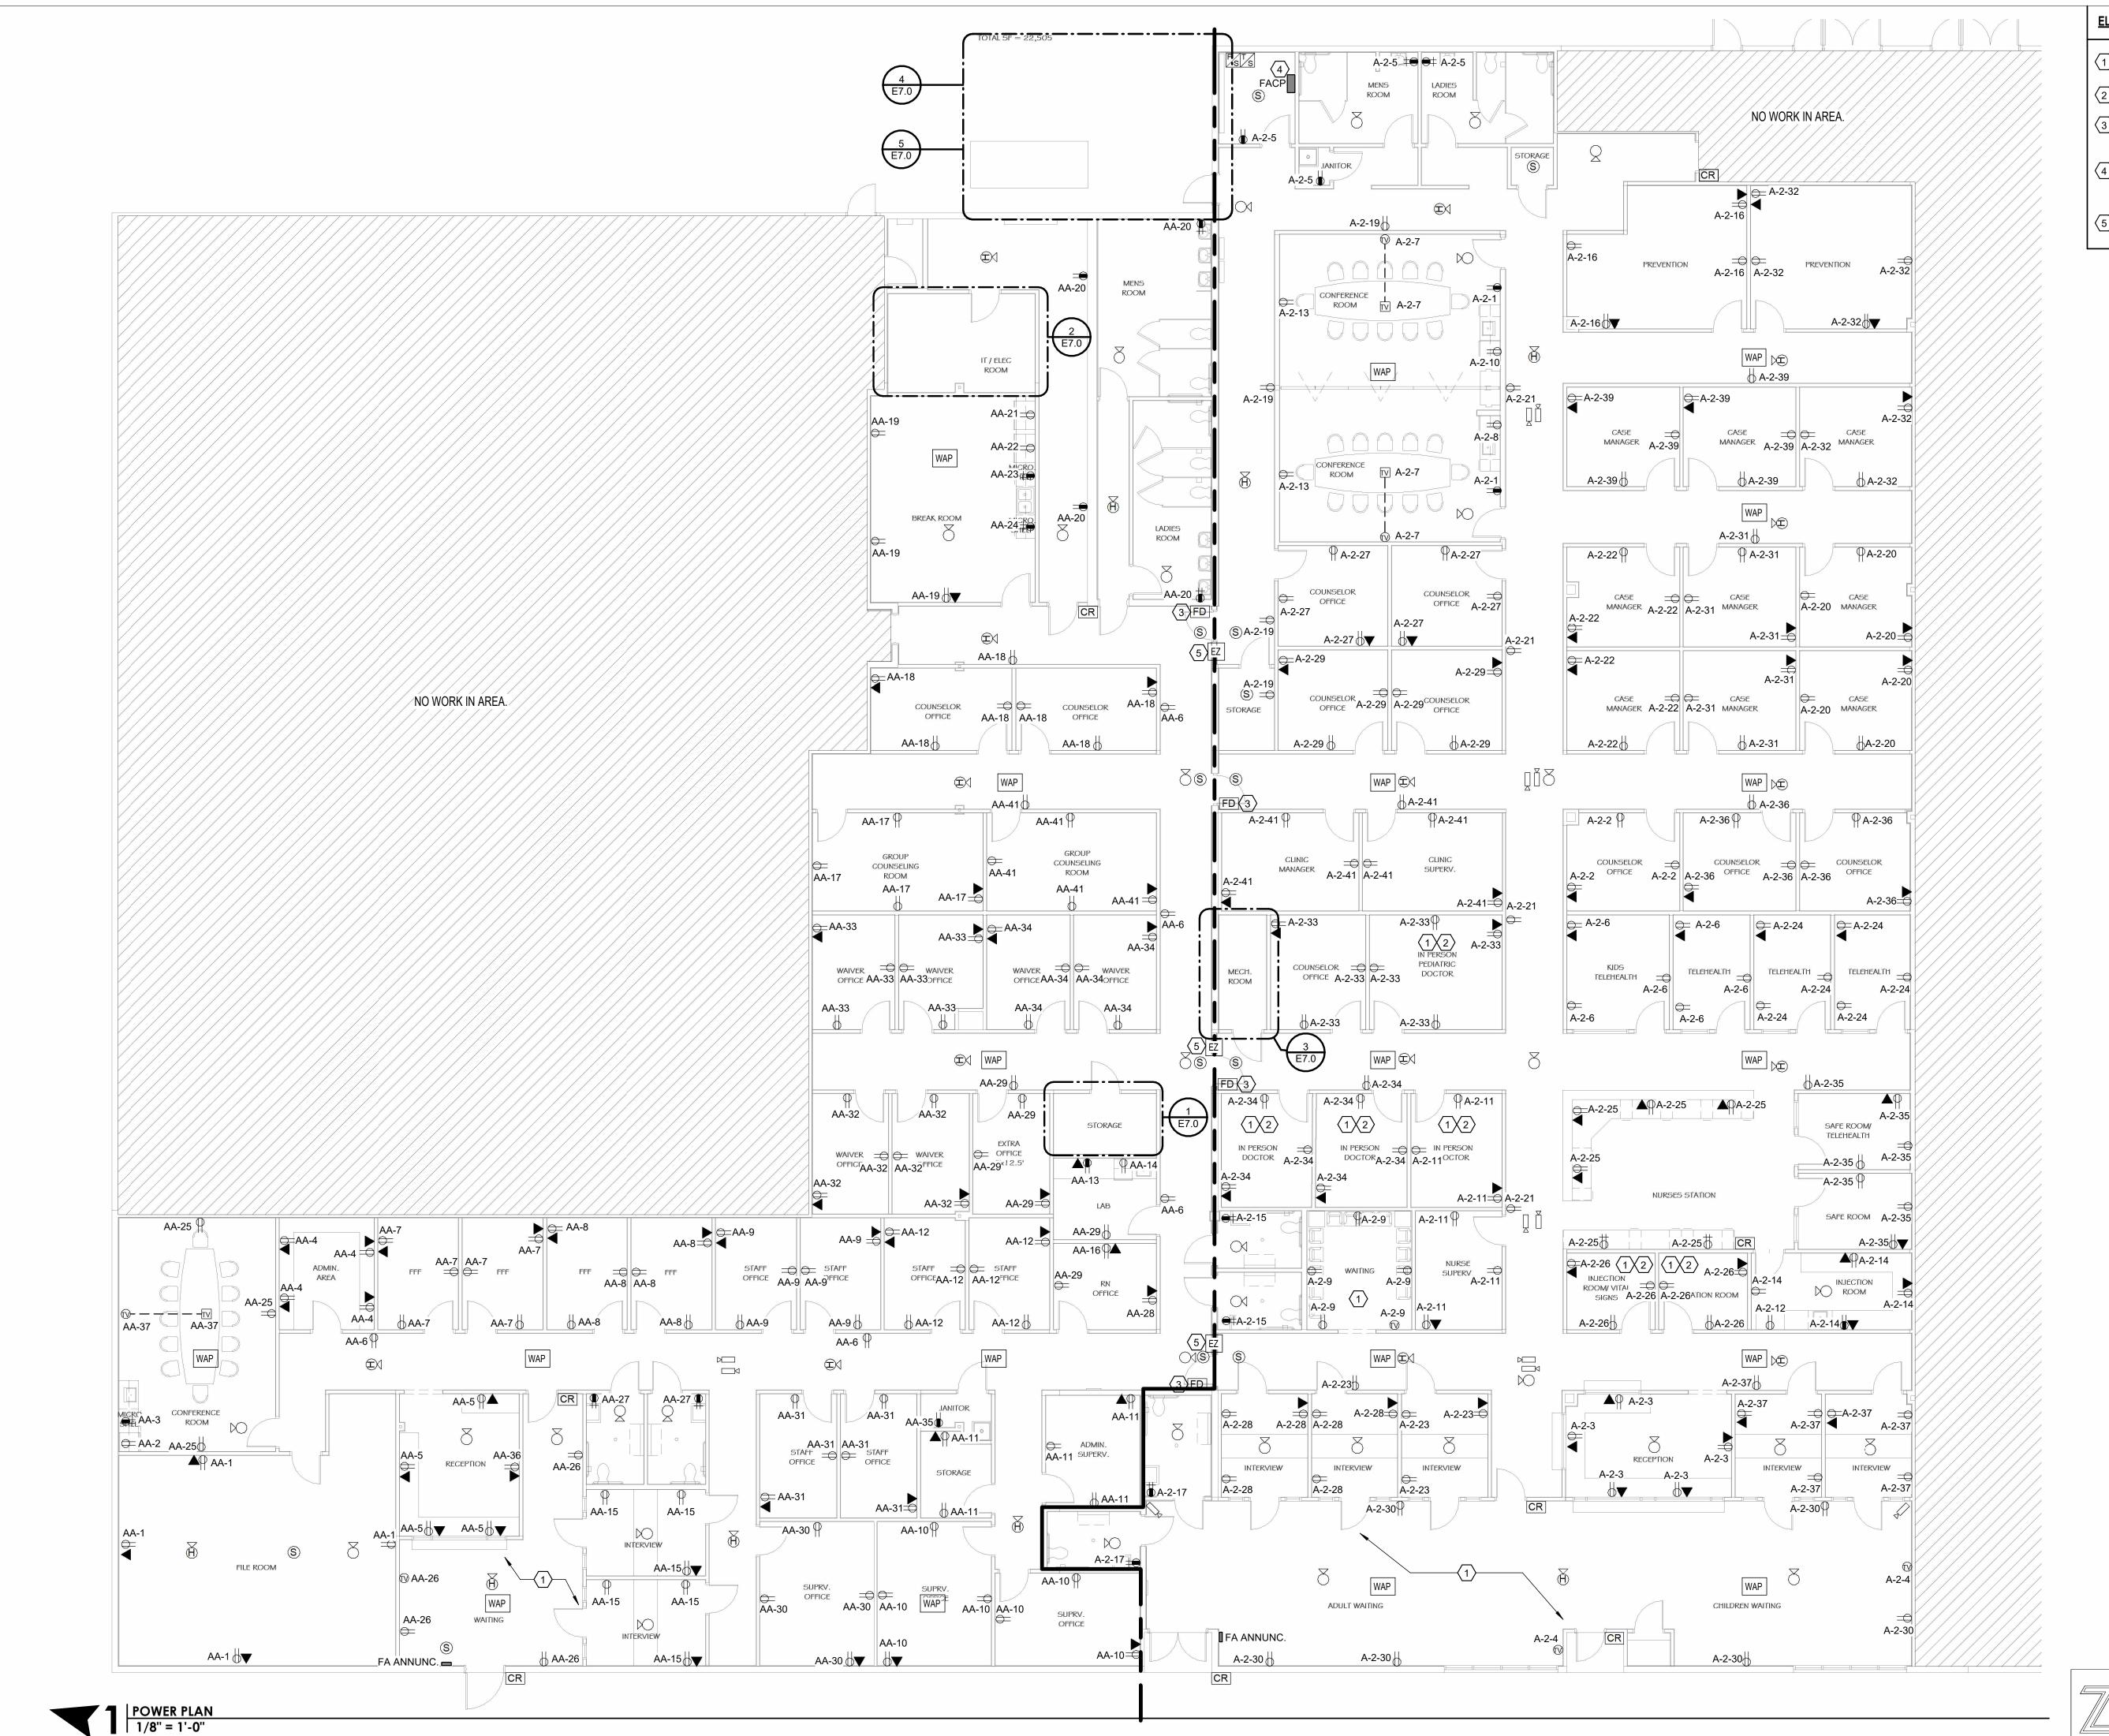

ELECTRICAL KEYED NOTES:

ALL RECEPTACLES IN AREA SHALL BE TAMPER RESISTANT.

MAUNFACTURER SPECIFICATIONS.

ALL RECEPTACLES AND WIRING IN AREA SHALL BE HOSPITAL GRADE.

FIRE DOOR MAGNETIC HOLD OPEN. INTERCONNECT TO FIRE ALARM SYSTEM AND PROVIDE LOW VOLTAGE CABLING AND RACEWAY PER

LANDLORD SHALL PROVIDE FIRE ALARM CONTROL PANEL (MAKE / MODEL : FIRE-LITE ES-200X). CONTRACTOR SHALL PROVIDE NOTIFICATION DEVICES AS SHOWN ON PLAN AND INTERCONNECT TO LANDLORD SYSTEM. CONTRACTOR SHALL PROVIDE ADDITIONAL REMOTE POWER SUPPLIES AS REQUIRED.

5 PROVIDE EASY FIRE RATED PATH (2) GANGED 4" MIN. MATCH FIRE

PROFESSIONAL ENGINEER

NO. SUBMISSION DATE

CONSTRUCTION SET 3/15/24

BAC

LDB

PROJECT NUMBER: 2023.04

OVERALL

POWER PLAN


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1. WHERE THE BREAKER RATING OF EQUIPMENT SERVED IS GREATER THAN THE DISCONNECT RATING ILLUSTRATED IN THE SCHEDULE. CONTRACTOR SHALL UPSIZE ACCORDINGLY TO PROVIDE PROPER PROTECTION TO THE EQUIPMENT SERVED.

MARK	SUPPLY FROM	CIRCUIT	REMARKS				
EF-1	A-1	29	C.				
EF-2	A-1	27	C.				
EF-3	В	8	C.				
EF-4	В	7	C.				
EF-5	A-1	33	C.				
EF-6	В	2	C.				
EUH-1	В	19,21,23	A.				
MSCU-1	A-1	19,21	B.				
RECIRC PUMP	В	11	A.				
RTU-1	A-1	1,3,5	G.				
RTU-2	A-1	2,4,6	G.				
RTU-3	A-1	7,9,11	D.				
RTU-4	AC	2,4,6	G.				
RTU-5	AC	1,3,5	G.				
RTU-6	A-1	8,10,12	E.				
RTU-7	AC	14,16,18	E.				
RTU-8	AC	8,10,12	E.				
RTU-9	AC	7,9,11	E.				
RTU-10	A-1	13,15,17	D.				
RTU-11	A-1	14,16,18	E.				
RTU-12	AC	13,15,17	G.				
RTU-13	AC	20,22,24	G.				
WH-1	В	13,15,17	F.				

MECHANICAL EQUIPMENT SCHEDULE REMARKS KEY:

- A. PROVIDE 30A NEMA 1 HEAVY DUTY MOTOR RATED TOGGLE SWITCH.
 B. PROVIDE 30A/15AF/N3R DISCONNECT.
- C. PROVIDE 30A/20AF/N3R DISCONNECT.
- D. PROVIDE 60A/40AF/N3R DISCONNECT.
- E. PROVIDE 60A/60AF/N3R DISCONNECT.
- F. PROVIDE 100A/70AF/N1 DISCONNECT
- G. PROVIDE 100A/70AF/N1 DISCONNECT

SOUTH CENTRAL LOUISIANA IUMAN SERVICES AUTHORITY

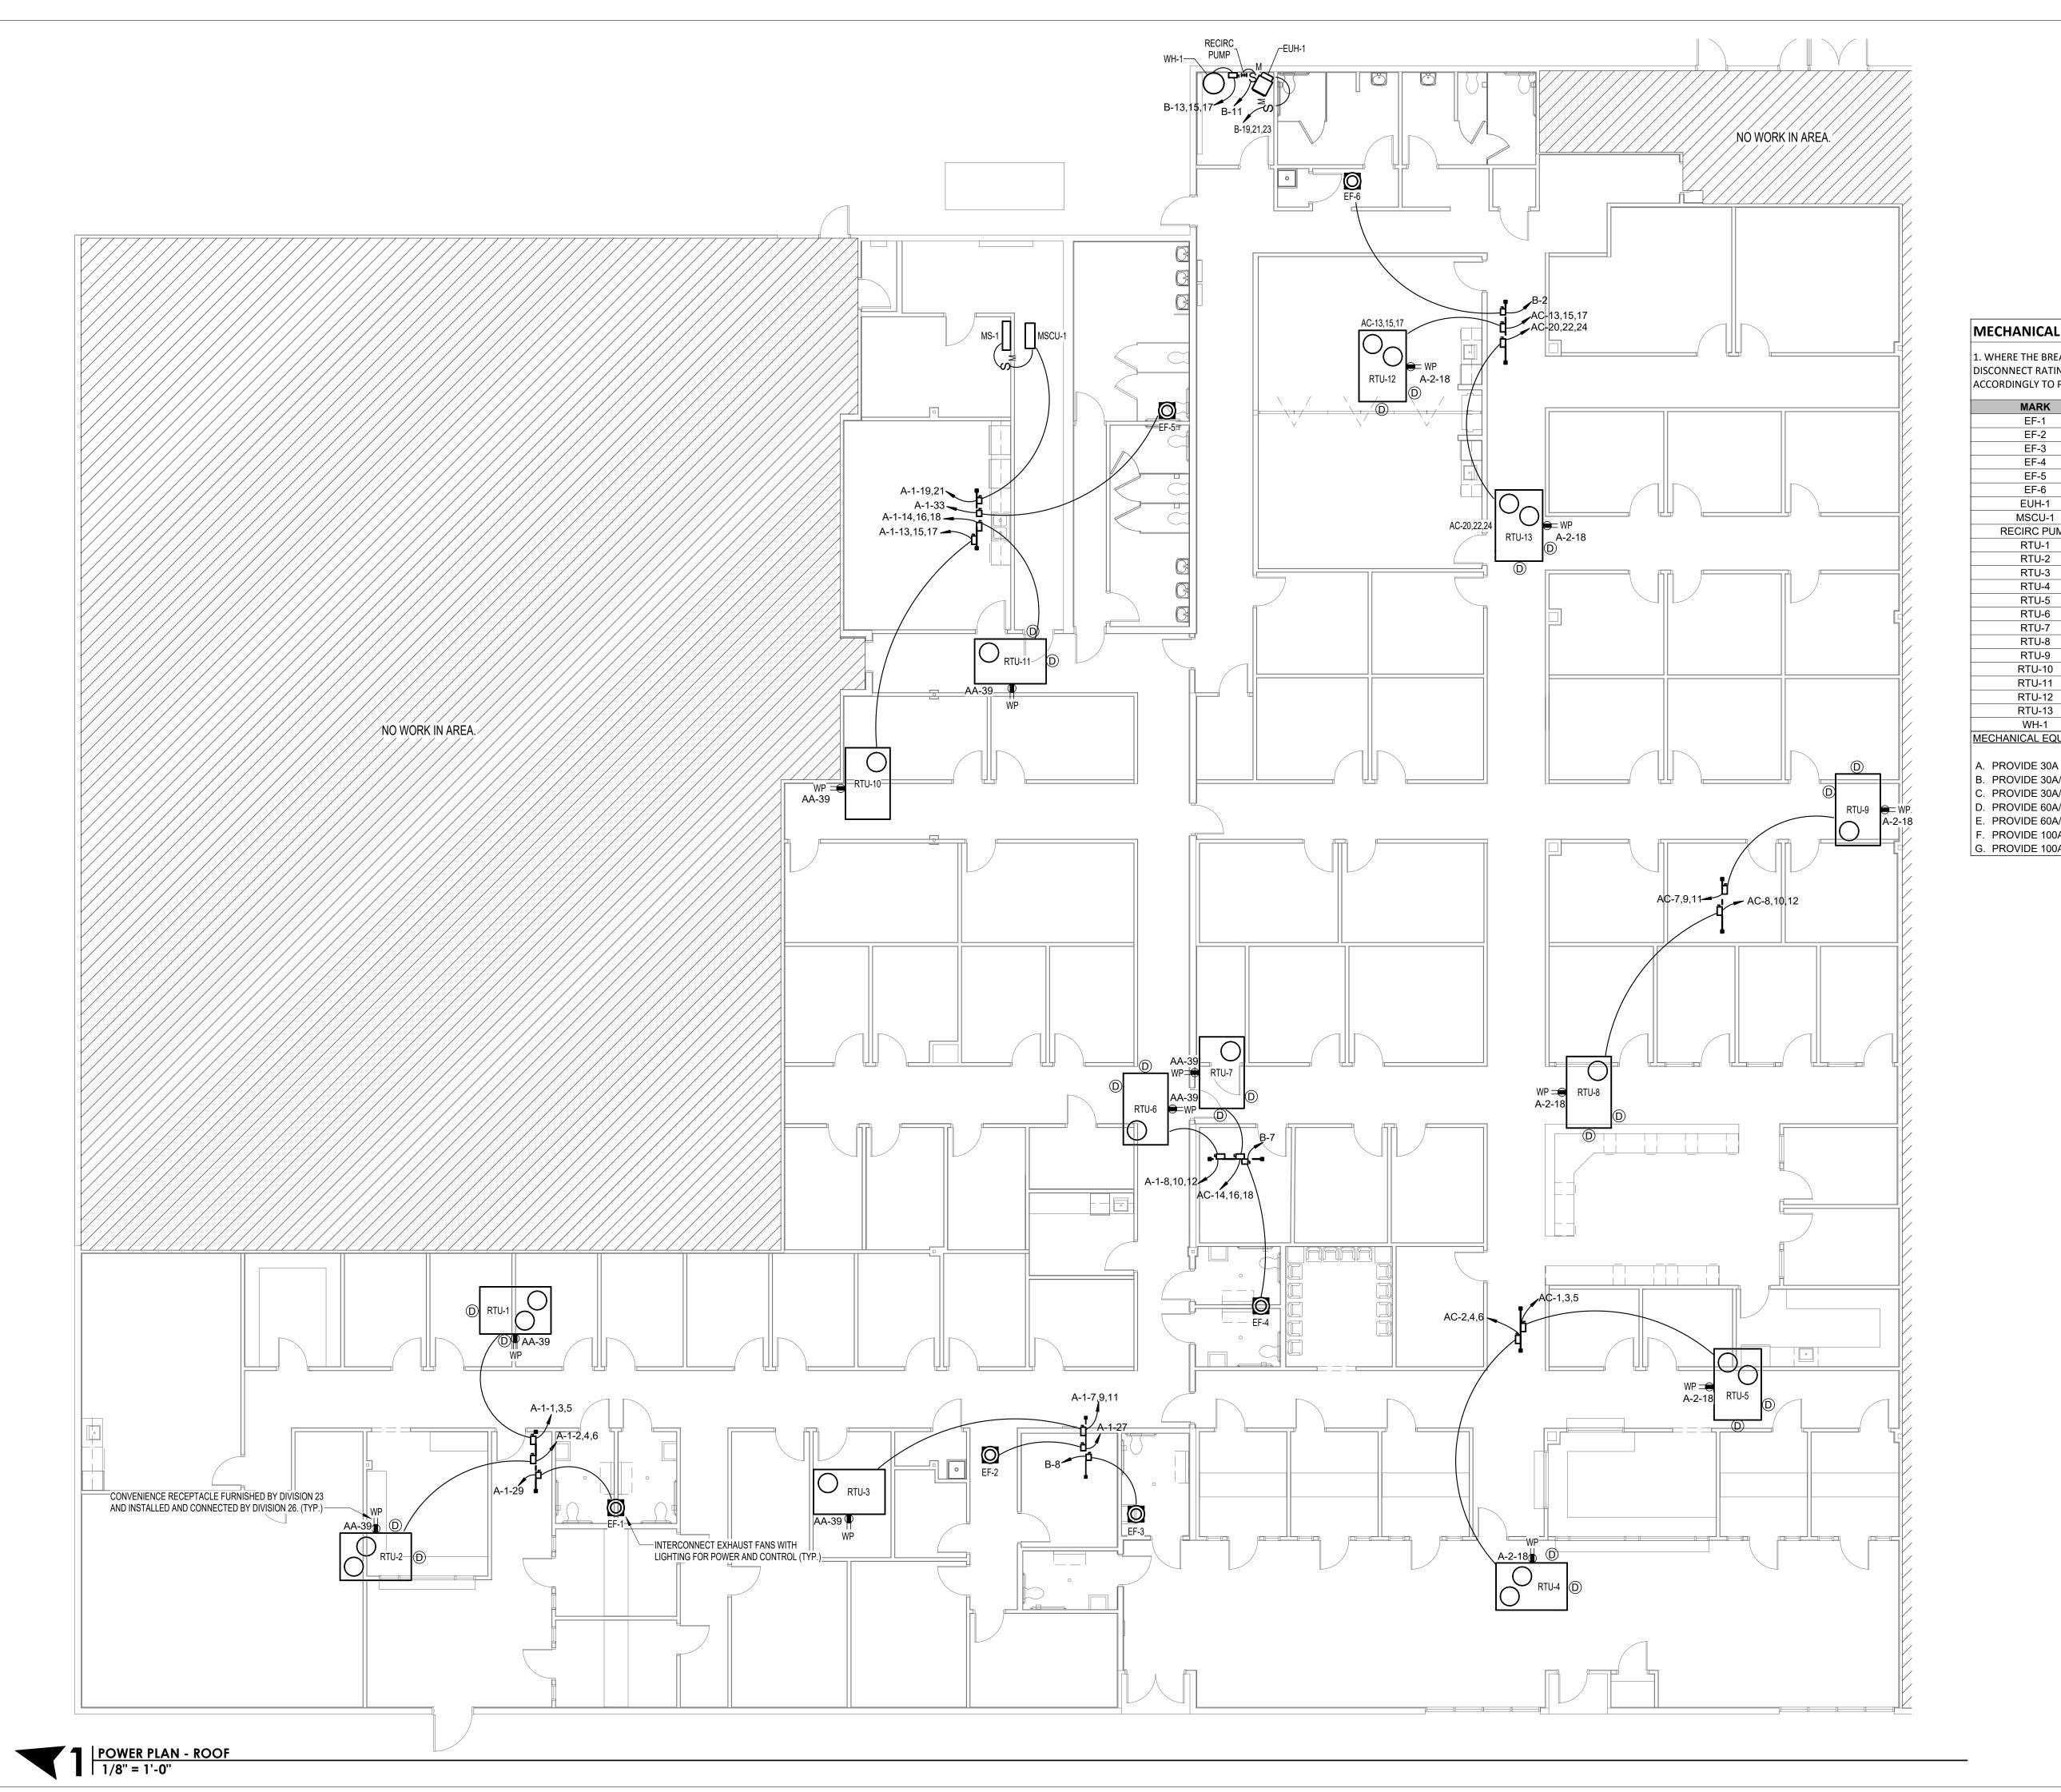NO. SUBMISSION DATE

1 CONSTRUCTION SET 3/15/24

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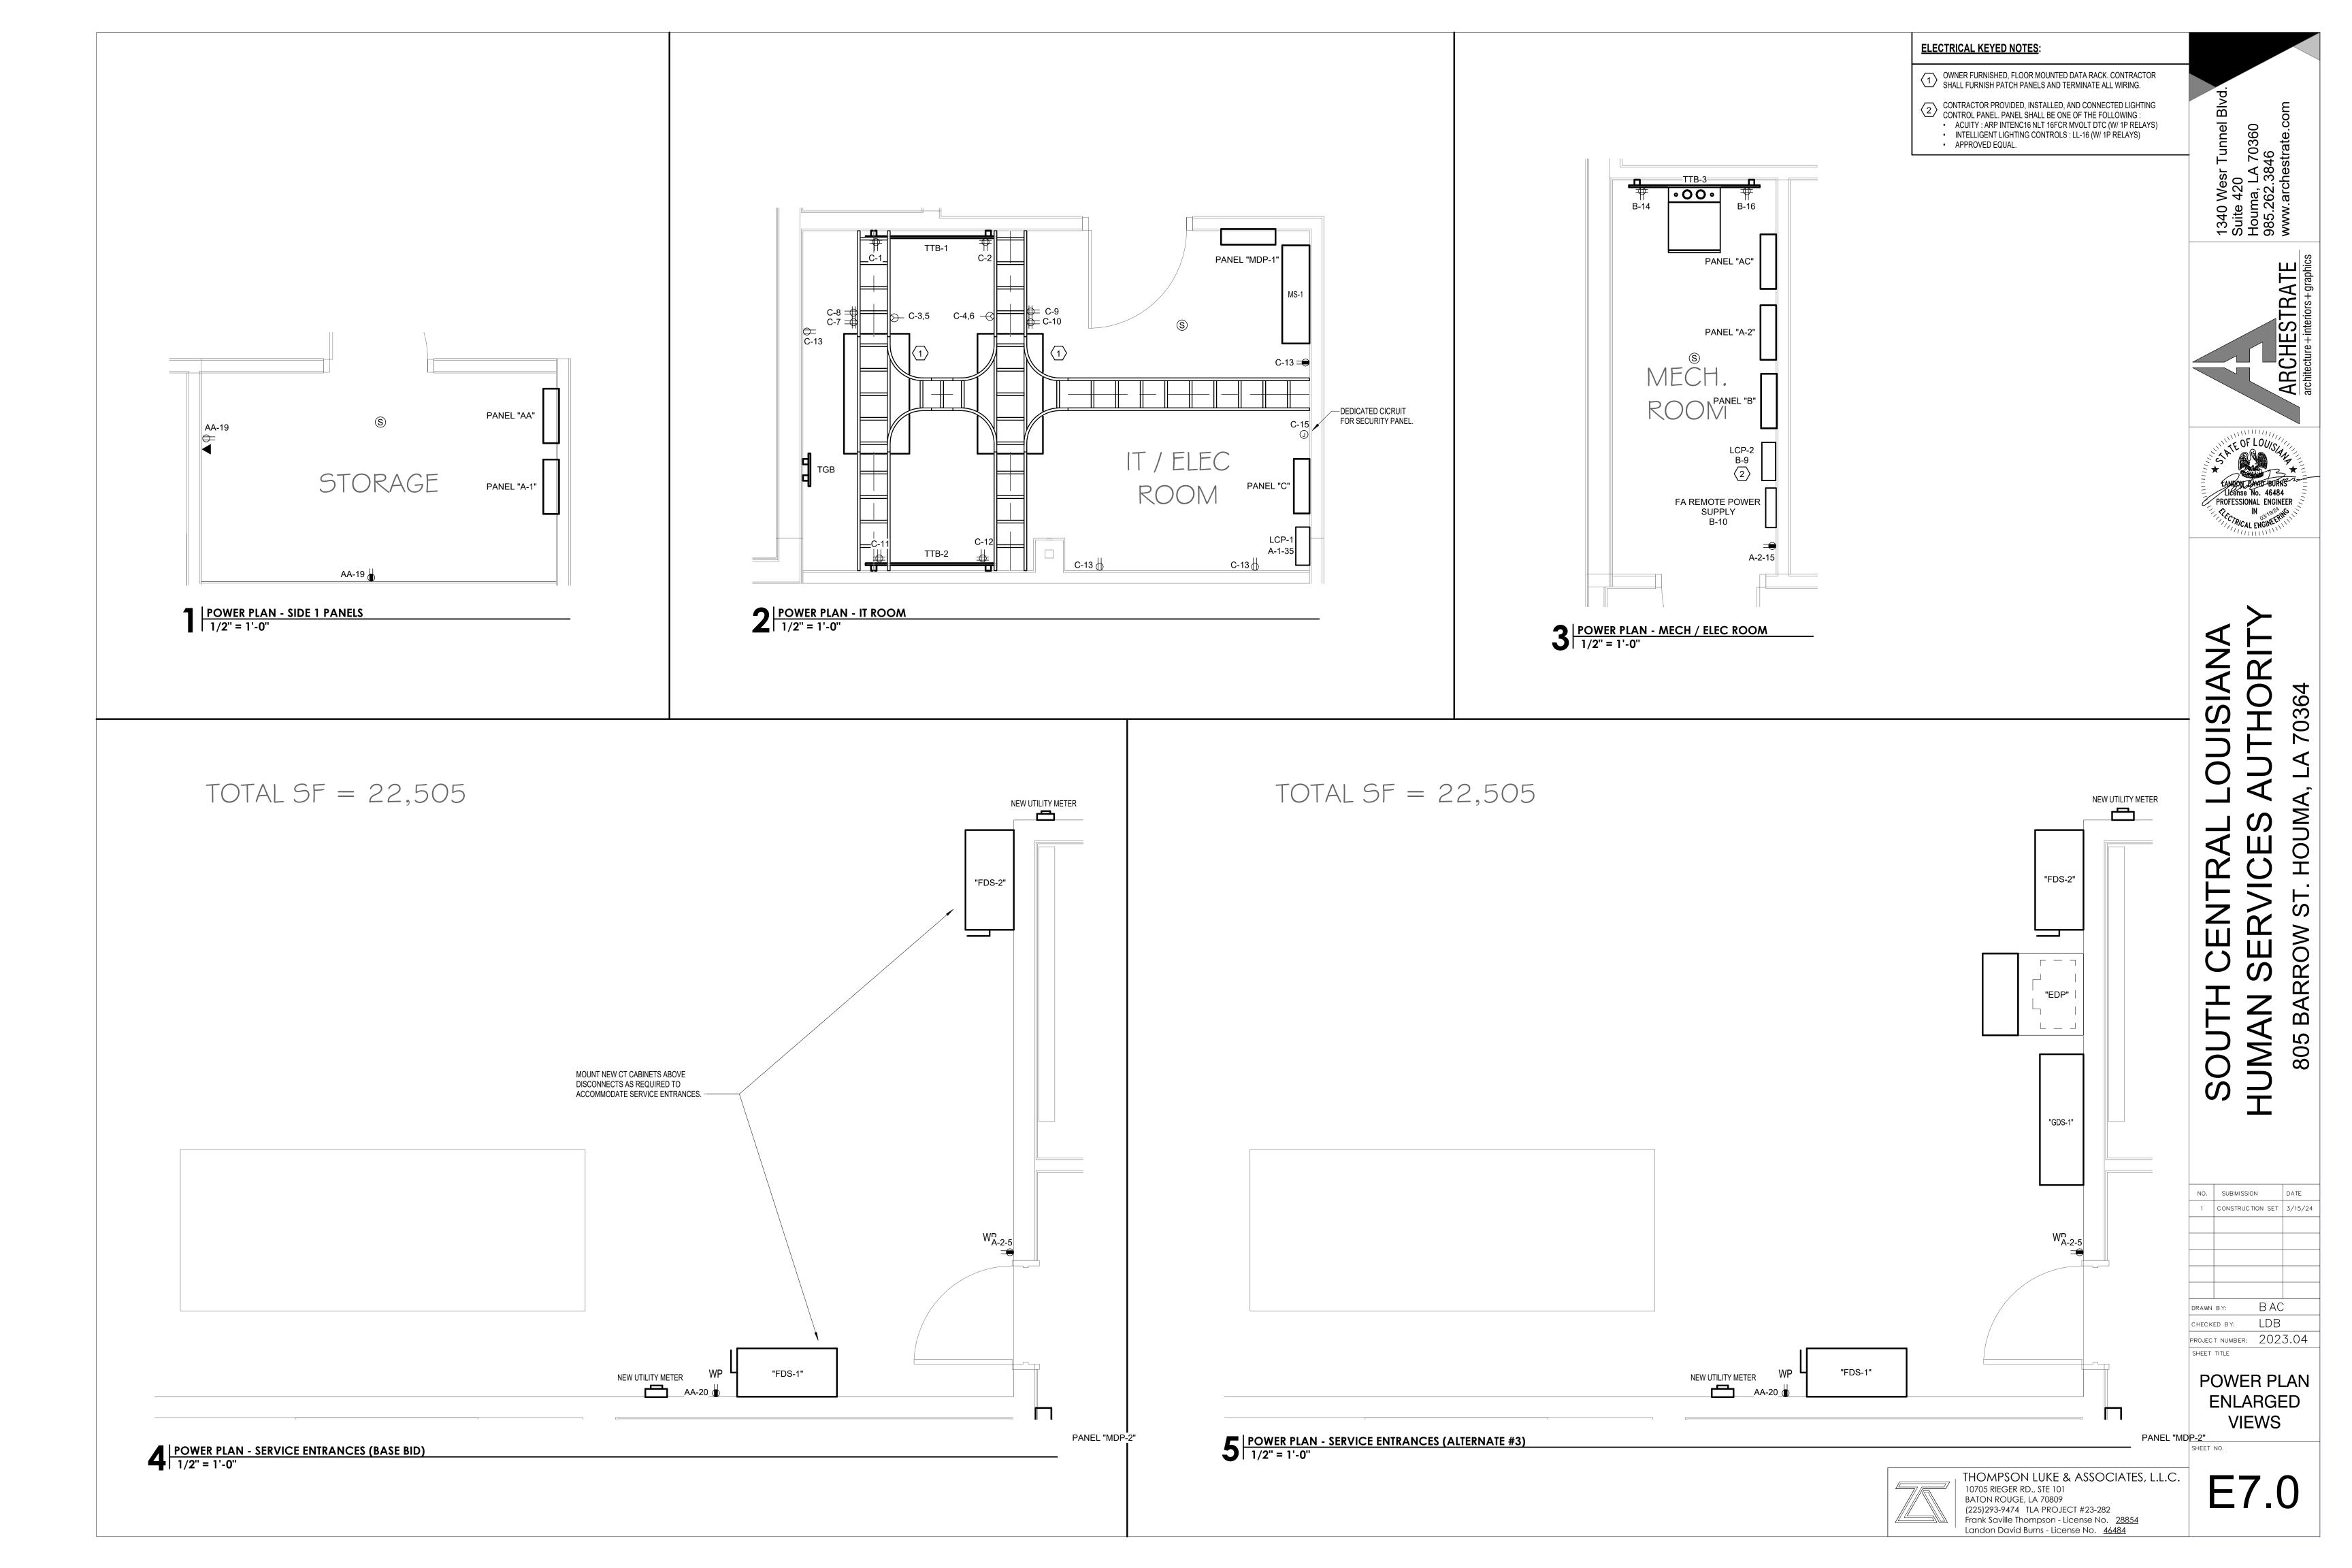
PROJECT NUMBER: 2023.04

SHEET TITLE

POWER PLAN

MECHANICAL








LIGHTING CONTROLS DESIGN INTENT:

- **RESTROOMS**: FIXTURES SHALL BE CONTROLLED VIA CEILING OR WALL MOUNTED OCCUPANCY SENSORS WITH MANUAL OVERRIDE. FIXTURES SHALL TURN ON AUTOMATICALLY AND TURN OFF AUTOMATICALLY AFTER 20 MINUTES OF INACTIVITY.
 - P. OFFICES / INDIVIDUAL SPACES: FIXTURES SHAL BE CONTROLLED VIA WALL MOUNTED VACANCY SENSOR SWITCH. FIXTURES SHALL BE SWITCHED ON MANUALLY AND AUTOMATICALLY TURN OFF AFTER 20 MINUTES OF INACTIVITY.
- **CORRIDORS / LOBBY:** FIXTURES SHALL BE CONTROLLED VIA LIGHTING CONTROL PANEL TO BE 100% ON DURING BUSINESS HOURS AND SHALL BE CONTROLLED VIA CEILING MOUNTED OCCUPANCY SENSORS AFTER HOURS. AFTER HOURS, FIXTURES SHALL TURN ON AUTOMATICALLY AND TURN OF AUTOMATICALLY AFTER 20 MINUTES OF INACTIVITY.
- MEETING / GROUP ROOMS: FIXTURES SHALL BE CONTROLLED VIA CEILING MOUNTED VACANCY SENSORS AND WALL MOUNTED OVERRIDES. FIXTURES SHALL BE SWITCHED ON MANUALLY AND AUTOMATICALLY TURN OFF AFTER 20 MINUTES OF INACTIVITY.



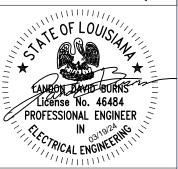

0364 HOUN TRAL BARROW 805

NO. SUBMISSION CONSTRUCTION SET 3/15/24

LDB CHECKED BY: PROJECT NUMBER: 2023.04

OVERALL LIGHTING PLAN



Relocated Panel: AA Location: Supply From:

Mounting: SURFACE

Enclosure: NEMA-1

Volts: 120/208 Wye Phases: 3 Wires: 4

A.I.C. Rating: 10,000 Mains Rating: 200 A

MLO Rating: 200 A

Number of Sections: 1 Panel Schedule Notes:

G - INDICATES GFCI BREAKER AND NEW CIRCUITRY N - INDICATES NEW BREAKER AND NEW CIRCUITRY

E - INDICATES EXISTING BREAKER TO BE REUSED FOR NEW CIRCUITRY

ABR CKT	TRIP	POLES	WIRE	GND	CONDUIT	Circuit Description	Δ	\	E	3	(С	Circuit Description	CONDUIT	GND	WIRE	POLES	TRIP	CKT ABR
E 1	20 A	1	2#10	1#10	3/4"	RCPT - FILE ROOM	0.7 kVA	0.2 kVA					RCPT - CONF ROOM	3/4"	1#10	2#10	1	20 A	2 E
E 3	20 A	1	2#10	1#10	3/4"	RCPT - CONF. ROOM			0.2 kVA	0.7 kVA			RCPT - ADMIN AREA	3/4"	1#10	2#10	1	20 A	4 E
E 5	20 A	1	2#10	1#10	3/4"	RCPT - RECEPTION					0.7 kVA	0.9 kVA	RCPT - CORRIDOR	3/4"	1#10	2#10	1	20 A	6 E
E 7	20 A	1	2#10	1#10	3/4"	RCPT - OFFICES	1.1 kVA	1.1 kVA					RCPT - OFFICES	3/4"	1#12	2#12	1	20 A	8 E
E 9	20 A	1	2#12	1#12	3/4"	RCPT - OFFICES			1.1 kVA	1.3 kVA			RCPT - OFFICES	3/4"	1#12	2#12	1	20 A	10 E
E 11	20 A	1	2#12	1#12	3/4"	RCPT - ADMIN / STORAGE					0.9 kVA	1.1 kVA	RCPT - OFFICES	3/4"	1#12	2#12	1	20 A	12 E
E 13	20 A	1	2#12	1#12	3/4"	RCPT - LAB / OFFICES	0.2 kVA	0.2 kVA					RCPT - LAB FRIDGE	3/4"	1#12	2#12	1	20 A	14 G
E 15	20 A	1	2#10	1#10	3/4"	RCPT - OFFICES			1.1 kVA	0.2 kVA			RCPT - COPIER	3/4"	1#12	2#12	1	20 A	16 E
E 17	20 A	1	2#12	1#12	3/4"	RCPT - OFFICES					0.7 kVA	1.3 kVA	RCPT - OFFICES	3/4"	1#12	2#12	1	20 A	18 E
E 19	20 A	1	2#12	1#12	3/4"	RCPT - BREAK ROOM	0.9 kVA	0.9 kVA					RCPT - RESTROOMS / ELEC	3/4"	1#10	2#10	1	20 A	20 E
G 21	20 A	1	2#12	1#12	3/4"	RCPT - BREAK ROOM			0.2 kVA	0.2 kVA			RCPT - BREAK ROOM	3/4"	1#12	2#12	1	20 A	22 E
E 23	20 A	1	2#12	1#12	3/4"	RCPT - BREAK ROOM					0.2 kVA	0.2 kVA	RCPT - BREAK ROOM	3/4"	1#12	2#12	1	20 A	24 E
E 25	20 A	1	2#10	1#10	3/4"	RCPT - CONFERENCE	0.5 kVA	1.0 kVA					RCPT - WAITING ROOM	3/4"	1#10	2#10	1	20 A	26 E
E 27	20 A	1	2#10	1#10	3/4"	RCPT - RESTROOMS			0.4 kVA	0.2 kVA			RCPT - COPIER	3/4"	1#12	2#12	1	20 A	28 E
E 29	20 A	1	2#12	1#12	3/4"	RCPT - MISC.					1.1 kVA	0.7 kVA	RCPT - OFFICE	3/4"	1#12	2#12	1	20 A	30 E
E 31	20 A	1	2#12	1#12	3/4"	RCPT - OFFICES	1.1 kVA	1.1 kVA					RCPT - OFFICE	3/4"	1#12	2#12	1	20 A	32 E
E 33	20 A	1	2#12	1#12	3/4"	RCPT - OFFICES			1.1 kVA	1.1 kVA			RCPT - OFFICES	3/4"	1#12	2#12	1	20 A	34 E
E 35	20 A	1	2#12	1#12	3/4"	RCPT - JANITOR					0.2 kVA	0.2 kVA	RCPT - COPIER	3/4"	1#10	2#10	1	20 A	36 E
E 37	20 A	1	2#10	1#10	3/4"	RCPT - CONFERENCE TV	1.0 kVA	0.0 kVA					(N) SPD				3	30 A	38
E 39	20 A	1	2#10	1#10	3/4"	RCPT - ROOF			1.3 kVA	0.0 kVA									40
E 41	20 A	1	2#12	1#12	3/4"	RCPT - OFFICES					0.9 kVA	0.0 kVA							42
							9960	VA	8820) VA	9000	0 VA							
							83	Α	74	Α	75	5 A							

Load Classification	Connected Load	Demand Factor	Estimated Demand	Panel Totals
Other	1500 VA	100.00%	1500 VA	
Receptacle	26280 VA	69.03%	18140 VA	Total Conn. Load: 27780 VA
				Total Est. Demand: 19640 VA
				Total Conn.: 77 A
				Total Est. Demand: 55 A
Load Summary Notes:	1	1		

Relo	ocated Panel: C		
	Location:	Volts : 120/208 Wye	A.I.C. Rating: 10,000
	Supply From:	Phases: 3	Mains Rating: 250 A
	Mounting: SURFACE	Wires: 4	MLO Rating: 250 A
	Enclosure: NEMA-1		•
	Number of Sections: 1		
Panel Schedule Note	es:		

G - INDICATES GFCI BREAKER AND NEW CIRCUITRY N - INDICATES NEW BREAKER AND NEW CIRCUITRY

E - INDICATES EXISTING BREAKER TO BE REUSED FOR NEW CIRCUITRY

ABR	CKT	TRIP	POLES	WIRE	GND	CONDUIT	Circuit Description		4	E	3		С	Circuit Description	CONDUIT	GND	WIRE	POLES	TRIP	CKT	ABR
E	1	20 A	1	2#10	1#12	3/4"	RCPT - TTB-1	0.4 kVA	0.4 kVA					RCPT - TTB-1	3/4"	1#10	2#10	1	20 A	2	Е
N	3	30 A	2	3#10	1#10	3/4"	RCPT - RACK 1			1.5 kVA	1.5 kVA			RCPT - RACK 2	3/4"	1#10	3#10	2	30 A	4	N
	5											1.5 kVA	1.5 kVA							6	
E	7	20 A	1	2#10	1#10	3/4"	RCPT - RACK 1	0.4 kVA	0.4 kVA					RCPT - RACK 1	3/4"	1#10	2#10	1	20 A	8	Е
E	9	20 A	1	2#10	1#10	3/4"	RCPT - RACK 2			0.4 kVA	0.4 kVA			RCPT - RACK 2	3/4"	1#10	2#10	1	20 A	10	Е
E	11	20 A	1	2#10	1#10	3/4"	RCPT - TTB - 2					0.4 kVA	0.4 kVA	RCPT - TTB-2	3/4"	1#10	2#10	1	20 A	12	Е
E	13	20 A	1	2#10	1#10	3/4"	RCPT - IT ROOM	0.7 kVA	0.0 kVA					(E) SPARE				1	20 A	14	
E	15	20 A	1	2#12	1#12	3/4"	SECURITY PANEL			0.5 kVA	0.0 kVA			(E) SPARE				1	20 A	16	
	17	20 A	1				(E) SPARE					0.0 kVA	0.0 kVA	(E) SPARE				1	20 A	18	
	19	20 A	1				(E) SPARE	0.0 kVA	0.0 kVA					(E) SPARE				1	20 A	20	
	21	20 A	1				(E) SPARE			0.0 kVA	0.0 kVA			(E) SPARE				1	20 A	22	
	23	20 A	1				(E) SPARE					0.0 kVA	0.0 kVA	(E) SPARE				1	20 A	24	
	25	20 A	1				(E) SPARE	0.0 kVA	0.0 kVA					(N) SPD				3	30 A	26	
	27	20 A	1				(E) SPARE			0.0 kVA	0.0 kVA									28	
	29	20 A	1				(E) SPARE					0.0 kVA	0.0 kVA							30	
								2160		4220			0 VA								
								18	Α	37	' A	33	3 A								

Load Classification	Connected Load	Demand Factor	Estimated Demand	Panel Totals
Other	500 VA	100.00%	500 VA	
Receptacle	3600 VA	100.00%	3600 VA	Total Conn. Load: 10100 VA
Miscellaneous	6000 VA	100.00%	6000 VA	Total Est. Demand: 10100 VA
				Total Conn.: 28 A
				Total Est. Demand: 28 A

Load Summary Notes:

Relocated Panel: A-1

Supply From: Mounting: SURFACE Enclosure: NEMA-1

Volts: 120/208 Wye Phases: 3 Wires: 4

A.I.C. Rating: 10,000

Mains Rating: 400 A MLO Rating: 400 A

Number of Sections: 1 Panel Schedule Notes:

G - INDICATES GFCI BREAKER AND NEW CIRCUITRY N - INDICATES NEW BREAKER AND NEW CIRCUITRY

E - INDICATES EXISTING BREAKER TO BE REUSED FOR NEW CIRCUITRY

ABR	СКТ	TRIP	POLES	WIRE	GND	CONDUIT	Circuit Description	ļ ,	A		3	(3	Circuit Description	CONDUIT	GND	WIRE	POLES	TRIP	CKT	ABR
N	1	80 A	3	4#4	1#8	1"	RTU-1	9.5 kVA	9.5 kVA					RTU-2	1"	1#8	4#4	3	80 A	2	N
	3									9.5 kVA	9.5 kVA									4	
	5											9.5 kVA	9.5 kVA							6	
N	7	40 A	3	1#10	4#6	3/4"	RTU-3	4.8 kVA	7.2 kVA					RTU-6	1"	1#10	4#4	3	60 A	8	N
	9									4.8 kVA	7.2 kVA									10	
	11											4.8 kVA	7.2 kVA							12	
N	13	40 A	3	1#10	4#6	3/4"	RTU-10	4.8 kVA	7.2 kVA					RTU-11	1"	1#10	4#4	3	60 A	14	N
	15									4.8 kVA	7.2 kVA									16	
	17											4.8 kVA	7.2 kVA							18	
N	19	15 A	2	3#12	1#12	3/4"	MSCU-1	1.3 kVA	0.0 kVA					(E) SPARE				1	20 A	20	
	21									1.3 kVA	0.0 kVA			(E) SPARE				1	20 A	22	
E	23	20 A	1	2#10	1#10	3/4"	LTG - OFFICES					0.9 kVA	0.0 kVA	(E) SPARE				1	20 A	24	
E	25	20 A	1	2#10	1#10	3/4"	LTG - FILE, RECEPTION,	0.9 kVA	0.0 kVA					(E) SPARE				1	20 A	26	
E	27	20 A	1	2#10	1#10	3/4"	LTG - CORRIDOR			0.9 kVA	0.0 kVA			(E) SPARE				1	20 A	28	
E	29	20 A	1	2#10	1#10	3/4"	LTG - OFFICES					0.5 kVA	0.0 kVA	(E) SPARE				1	20 A	30	
E	31	20 A	1	2#10	1#10	3/4"	LTG - OFFICES	0.6 kVA	0.0 kVA					(E) SPARE				1	20 A	32	
E	33	20 A	1	2#10	1#10	3/4"	LTG - BREAK, ELEC, RR			0.8 kVA	0.0 kVA			(E) SPARE				1	20 A	34	
E	35	20 A	1	2#12	1#12	3/4"	LCP-1					0.5 kVA	0.0 kVA	(E) SPARE				1	20 A	36	
	37	20 A	1				(E) SPARE	0.0 kVA	0.0 kVA					(N) SPD				3	30 A	38	
	39	20 A	1_				(E) SPARE	_		0.0 kVA	0.0 kVA									40	
	41	20 A	1				(E) SPARE					0.0 kVA	0.0 kVA							42	
								4584	2 VA	4605	9 VA	4494	4 VA								
								383	3 A	38	5 A	37	5 A								

Load Classification	Connected Load	Demand Factor	Estimated Demand	Panel	Totals
Other	131850 VA	100.00%	131850 VA		
Power	0 VA	0.00%	0 VA	Total Conn. Load:	136845 VA
Lighting	4495 VA	125.00%	5619 VA	Total Est. Demand:	137969 VA
Miscellaneous	500 VA	100.00%	500 VA	Total Conn.:	380 A
				Total Est. Demand:	383 A
Load Summary Notes:					

LIGHTING FIXTURE SCHEDULE

** FINISH TO BE SELECTED BY ARCHITECT | FIXTURE COUNT IS PROVIDED FOR REFERENCE ONLY, CONTRACTOR IS RESPONSIBLE FOR DETERMINING EXACT QTY.

								APPROVED FIXTURES							
MARK	DESCRIPTION	LAMPS	VOLTS	LOAD	TEMP.	LUMENS	MOUNTING		OPTION 1	OPTION 2					
								MANUFACTURER	CATALOG NO.	MANUFACTURER	CATALOG NO.				
A1	SELECTABLE LUMEN/COLOR TEMP 2'X4' LED FLAT PANEL	LED	UNV	30 VA	3,500	4,000	GRID/SURFACE	LITHONIA LIGHTING	CPX 2X4 AL08 SWW7 SWL	METALUX	24FPSL2SCT3				
A2	SELECTABLE LUMEN/COLOR TEMP 2'X4' LED FLAT PANEL	LED	UNV	50 VA	3,500	6,000	GRID/SURFACE	LITHONIA LIGHTING	CPX 2X4 AL08 SWW7 M2 SWL	METALUX	24FPSL2SCT3				
В	SELECTABLE LUMEN/COLOR TEMP 2'X2' LED FLAT PANEL	LED	UNV	25 VA	3,500	2,500	GRID/SURFACE	LITHONIA LIGHTING	CPX 2X2 AL01 SWW7 M4	METALUX 22FPSL2SCT3					
С	HIGH BAY LED. PROVIDE SUSPENSION HARDWARE AS REQUIRED AND MOUNT AT 12' A.F.F.	LED	UNV	100 VA	3,500	12,000	SUSPENDED	LITHONIA LIGHTING	IBL-12L-WD-LP835	METALUX	OHBL-12-SE-W-UNV-L835				
EM	EMERGENCY LIGHTING UNIT EQUIPMENT WITH TWO ADJUSTABLE LED HEADS. INTEGRAL BATTERY WITH SELF-DIAGNOSTICS.	LED	UNV	1 VA	N/A	N/A	CEILING/WALL	LITHONIA LIGHTING	ELM6L	SURE LITES	SEL25				
Х	EXIT SIGN WITH RED LETTERS. PROVIDE WITH NUMBER OF FACES AND DIRECTIONAL ARROWS AS INDICATED. FIXTURE SHALL BE PROVIDED WITH INTEGRAL BATTERY BACKUP AND SELF-DIAGONSTICS.	N/A	UNV	1 VA	N/A	N/A	CEILING/WALL	LITHONIA LIGHTING	LQM	SURE LITES	LPX				
XC	COMBO UNIT EXIT SIGN WITH RED LETTERS AND TWO ADJUSTABLE LED HEADS. PROVIDE WITH NUMBER OF FACES AND DIRECTIONAL ARROWS AS INDICATED. FIXTURE SHALL BE PROVIDED WITH INTEGRAL BATTERY BACKUP AND SELF-DIAGONSTICS.	LED	UNV	1 VA	N/A	N/A	CEILING/WALL	LITHONIA LIGHTING	LHQM	SURE LITES	LPXC				
Z	WET LOCATION LED EMERGENCY UNIT EQUIPMENT WITH INTEGRAL BATTERY BACKUP	LED	UNV	1 VA	N/A	N/A	WALL	LITHONIA LIGHTING	AFF-OEL-**-UVOLT-LTP-SDRT-WT	SURE LITES	SELW-25-**				

NO. SUBMISSION DATE CONSTRUCTION SET 3/15/24 BAC DRAWN BY:

LDB

805

ELECTRICAL SCHEDULES 1

PROJECT NUMBER: 2023.04

CHECKED BY:

SHEET TITLE



Load Summary Notes:

3 - INI	DICA		Notes: FCI BRE	Number AKER <i>A</i>	Mou Mou Encl of Sec	cation: From: Inting: SUI osure: NEI ctions: 1 EW CIRCUIT W CIRCUIT	MA-1 ITRY	CATES EXISTING	BREAKEF	Phases: Wires:	4		CUITRY	Mains I	Rating: 10,000 Rating: 600 A Rating: 600 A)						
ABR (СКТ	TRIP	POLES	WIRE	GND	CONDUIT	Circuit Description	, A			3		C	Circuit Description	CONDUIT	GND	WIRE	POLES	TRIP	СКТ	AB	
N	1	80 A	3	4#4	1#8	1"	RTU-5	9.5 kVA	9.5 kVA	-				RTU-4	1"	1#8	4#4	3	80 A		N	
	3									9.5 kVA	9.5 kVA									4	-	
	5	-										9.5 kVA	9.5 kVA							6	-	
E	7	60 A	3	4#6	1#10	1"	RTU-9	7.2 kVA	7.2 kVA					RTU-8	1"	1#10	4#6	3	60 A			
	9									7.2 kVA	7.2 kVA										<u> </u>	
	11											7.2 kVA	7.2 kVA									
		80 A	3	4#4	1#8	1"	RTU-12	9.5 kVA	7.2 kVA					RTU-7	1"	1#10	4#6	3			E	
	15									9.5 kVA	7.2 kVA	0.511/4	7011/4								-	
	17						 (E) ODADE	0.011/4	0.511/4			9.5 kVA	7.2 kVA		1"	4.40						
		60 A	3				(E) SPARE	0.0 kVA	9.5 kVA	0.012/4	0.51374			RTU-13	<u>'</u>	1#8	4#4	3				
	21									0.0 kVA	9.5 kVA	0.014/4	9.5 kVA	-						22	-	
	23 25	 60 A	3				(E) SPARE	0.0 kVA	0.0 kVA			0.0 kVA	9.5 KVA	 (N) SPD				3			_	
	27						(E) SFARE	U.U KVA	U.U KVA	0.0 kVA	0.0 kVA			(N) 3FD						28	_	
	29									0.0 KVA	0.0 KVA	0 0 kV/A	0.0 kVA							30		
	23						1	5965	∩ \/Δ	5065	50 VA		50 VA							1 00		
								497		49			7 A									
								407	A	10		13	<i>T</i> A									
oad	Clas	sificati	on				Coi	nnected Load	D	emand Fac	tor	Estimat	ted Demand	ı	Par	nel Tota	als					
ther								178950 VA		100.00%		178	3950 VA						4 6 10 12 16 18 18 22 24 28 28 28 16 18 18 ower	•							0 VA		0.00%			0 VA	To	otal Conn. Loa	nd: 178	3950 VA					
2								— • • • • • • • • • • • • • • • • • • •		3.3073					tal Est. Demar							
														100	Total Con							
														I OI	tal Est. Deman	ıa: 49/	А					
									1		I .			1		1						

Relocated Panel: B

Location: Supply From: Mounting: SURFACE Enclosure: NEMA-1

Volts: 120/208 Wye Phases: 3 Wires: 4

A.I.C. Rating: 10,000 Mains Rating: 250 A MLO Rating: 250 A

Number of Sections: 1 Panel Schedule Notes:

G - INDICATES GFCI BREAKER AND NEW CIRCUITRY N - INDICATES NEW BREAKER AND NEW CIRCUITRY

E - INDICATES EXISTING BREAKER TO BE REUSED FOR NEW CIRCUITRY

ABR	CKT	TRIP	POLES	WIRE	GND	CONDUIT	Circuit Description	A	١	į i	3	C	3	Circuit Description	CONDUIT	GND	WIRE	POLES	TRIP	CKT	ABR
Е	1	20 A	1	2#10	1#10	3/4"	LTG - CORRIDORS	0.6 kVA	0.4 kVA					LTG - RESTROOMS	3/4"	1#10	2#10	1	20 A	2	E
Е	3	20 A	1	2#10	1#10	3/4"	LTG - CONF / OFFICES			0.6 kVA	0.6 kVA			LTG - OFFICES	3/4"	1#10	2#10	1	20 A	4	E
Е	5	20 A	1	2#10	1#10	3/4"	LTG - OFFICES					0.8 kVA	0.8 kVA	LTG - CORRIDORS	3/4"	1#10	2#10	1	20 A	6	E
Е	7	20 A	1	2#10	1#10	3/4"	LTG - OFFICES / NURSES	0.8 kVA	0.9 kVA					LTG - LOBBY / INTERVIEWS	3/4"	1#10	2#10	1	20 A	8	E
Е	9	20 A	1	2#12	1#12	3/4"	LCP-2			0.5 kVA	0.7 kVA			FA REMOTE POWER	3/4"	1#12	2#12	1	20 A	10	E
Е	11	20 A	1	2#12	1#12	3/4"	RECIRC PUMP					0.1 kVA	0.5 kVA	FACP	3/4"	1#12	2#12	1	20 A	12	E
Ν	13	70 A	3	4#6	1#8	1"	WATER HEATER	4.0 kVA	0.4 kVA					RCPT - TTB	3/4"	1#12	2#12	1	20 A	14	E
	15									4.0 kVA	0.4 kVA			RCPT - TTB	3/4"	1#12	2#12	1	20 A	16	E
	17											4.0 kVA	0.0 kVA	(E) SPARE				1	20 A	18	
Ν	19	20 A	3	4#12	1#12	3/4"	EUH-1	1.3 kVA	0.0 kVA					(E) SPARE				1	20 A	20	
	21									1.3 kVA	0.0 kVA			(E) SPARE				1	20 A	22	
	23											1.3 kVA	0.0 kVA	(E) SPARE				1	20 A	24	
	25	20 A	1				(E) SPARE	0.0 kVA	0.0 kVA					(E) SPARE				1	20 A	26	
	27	20 A	1				(E) SPARE			0.0 kVA	0.0 kVA			(E) SPARE				1	20 A	28	
	29	20 A	1				(E) SPARE					0.0 kVA	0.0 kVA	(E) SPARE				1	20 A	30	
	31	20 A	1				(E) SPARE	0.0 kVA	0.0 kVA					(E) SPARE				1	20 A	32	
	33	20 A	1				(E) SPARE			0.0 kVA	0.0 kVA			(E) SPARE				1	20 A	34	
	35	20 A	1				(E) SPARE					0.0 kVA	0.0 kVA	(N) SPARE				1	20 A	36	
	37	20 A	1				(E) SPARE	0.0 kVA	0.0 kVA					(N) SPD				3	30 A	38	
	39	20 A	1				(E) SPARE			0.0 kVA	0.0 kVA									40	
	41	20 A	1				(E) SPARE					0.0 kVA	0.0 kVA							42	
•	'							8343	3 VA	816	3 VA	7493	3 VA								
								70	Α	69) A	62	Α								

Load Classification	Connected Load	Demand Factor	Estimated Demand	Panel Totals
Other	16150 VA	100.00%	16150 VA	
Receptacle	720 VA	100.00%	720 VA	Total Conn. Load: 24005 VA
Power	0 VA	0.00%	0 VA	Total Est. Demand: 25359 VA
Lighting	5415 VA	125.00%	6769 VA	Total Conn.: 67 A
Miscellaneous	1720 VA	100.00%	1720 VA	Total Est. Demand: 70 A

Load Summary Notes:





UISIAN 0364 805


NO. SUBMISSION CONSTRUCTION SET 3/15/24

LDB CHECKED BY: PROJECT NUMBER: 2023.04 SHEET TITLE

> **ELECTRICAL** SCHEDULES 2

E10.0



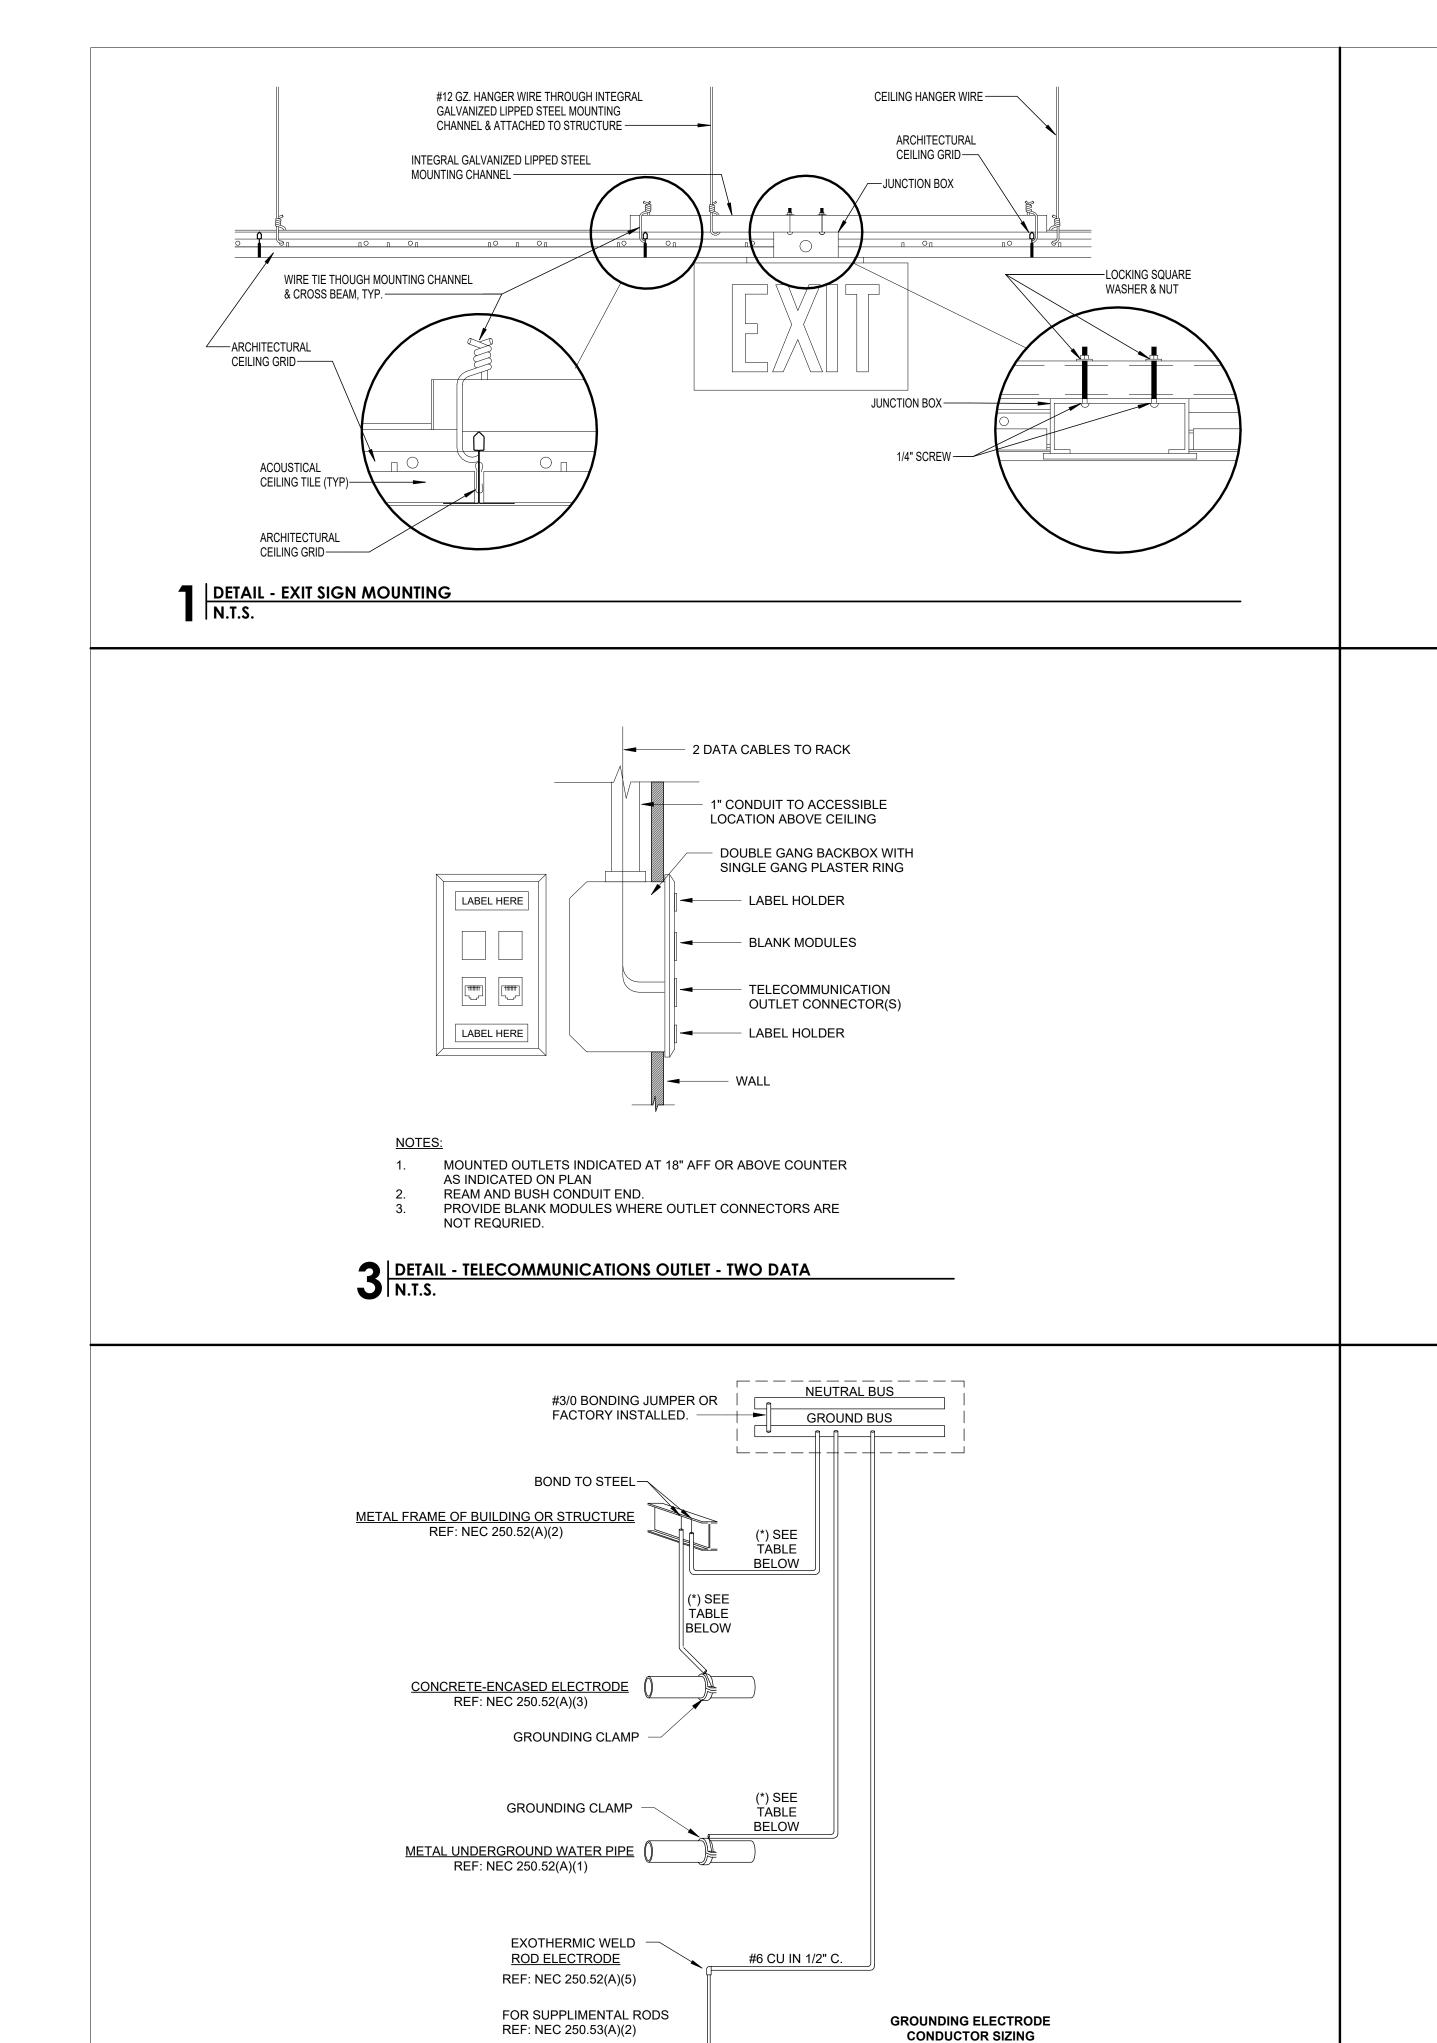

SERVICE SIZE

400AMPS OR LESS 600 OR

800AMPS


OR MORE

DETAIL - BUILDING GROUNDING N.T.S.


#1/0 CU IN 3/4" C.


#2/0 CU IN 3/4" C.

#3/0 CU IN 1" C.

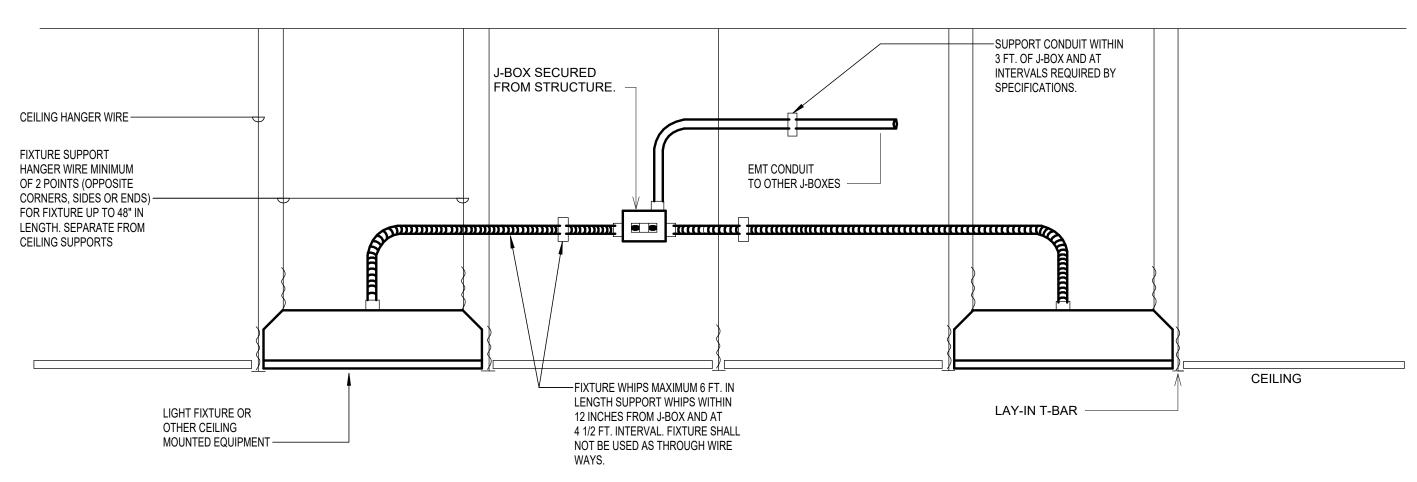

2 DETAIL - LAY-IN FIXTURE MOUNTING DETAIL N.T.S.

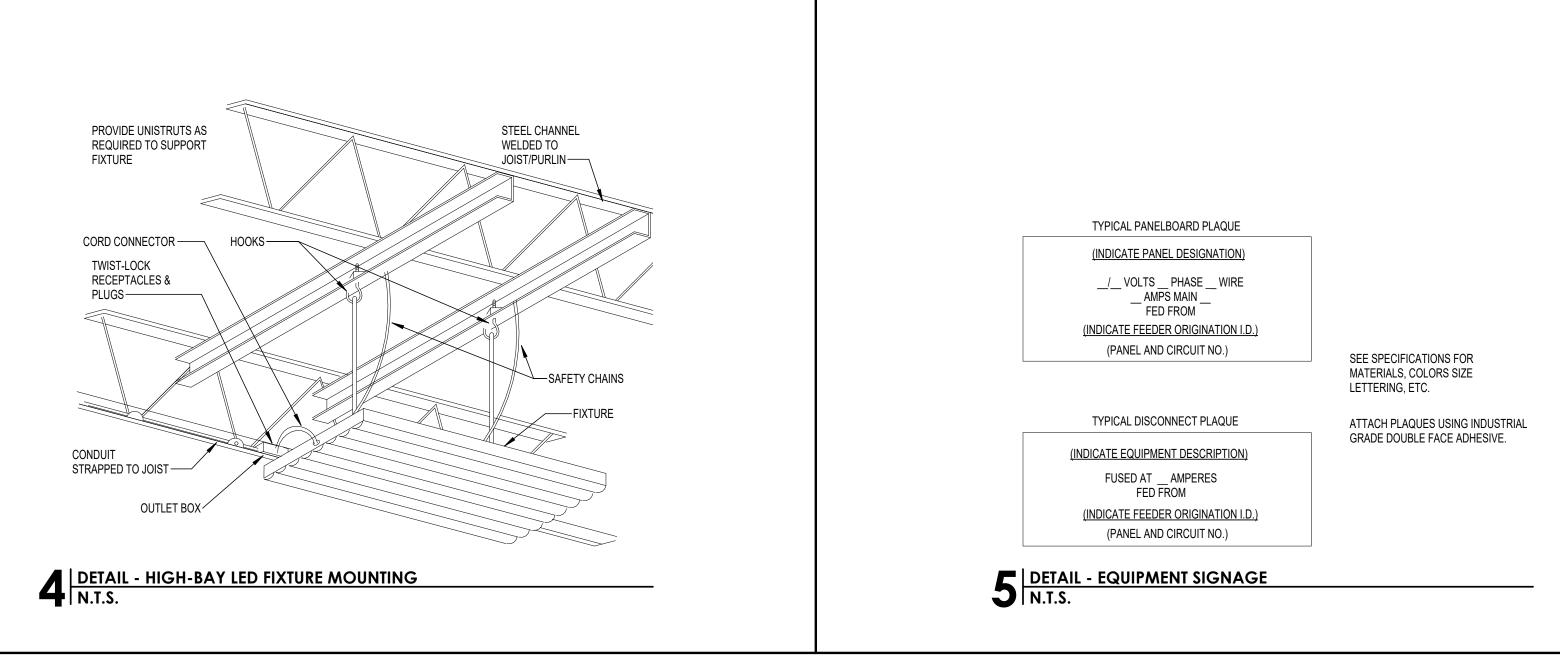

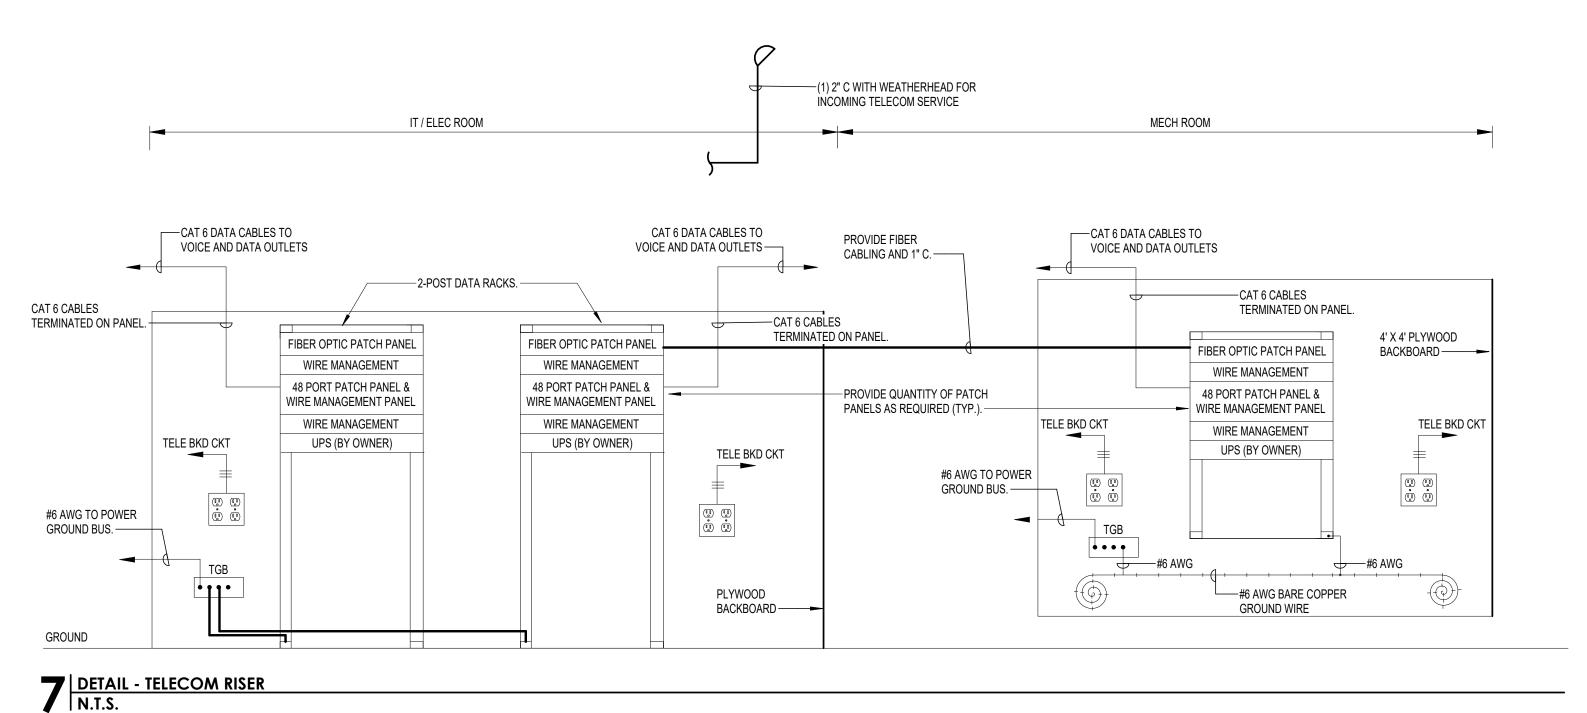



805

NO. SUBMISSION DATE

CONSTRUCTION SET 3/15/24

ВАС

LDB

PROJECT NUMBER: 2023.04

ELECTRICAL

DETAILS

DRAWN BY:

CHECKED BY:

SHEET TITLE